

BONANZA ROAD ELEVATION

SCALE 3/16" = 1'-0"


PROPOSED REBUILD L.V. CLEMENT SERVICE STATION

BONANZA ROAD & 'H' STREET

LAS VEGAS


NEVADA

Jan 28 - 34

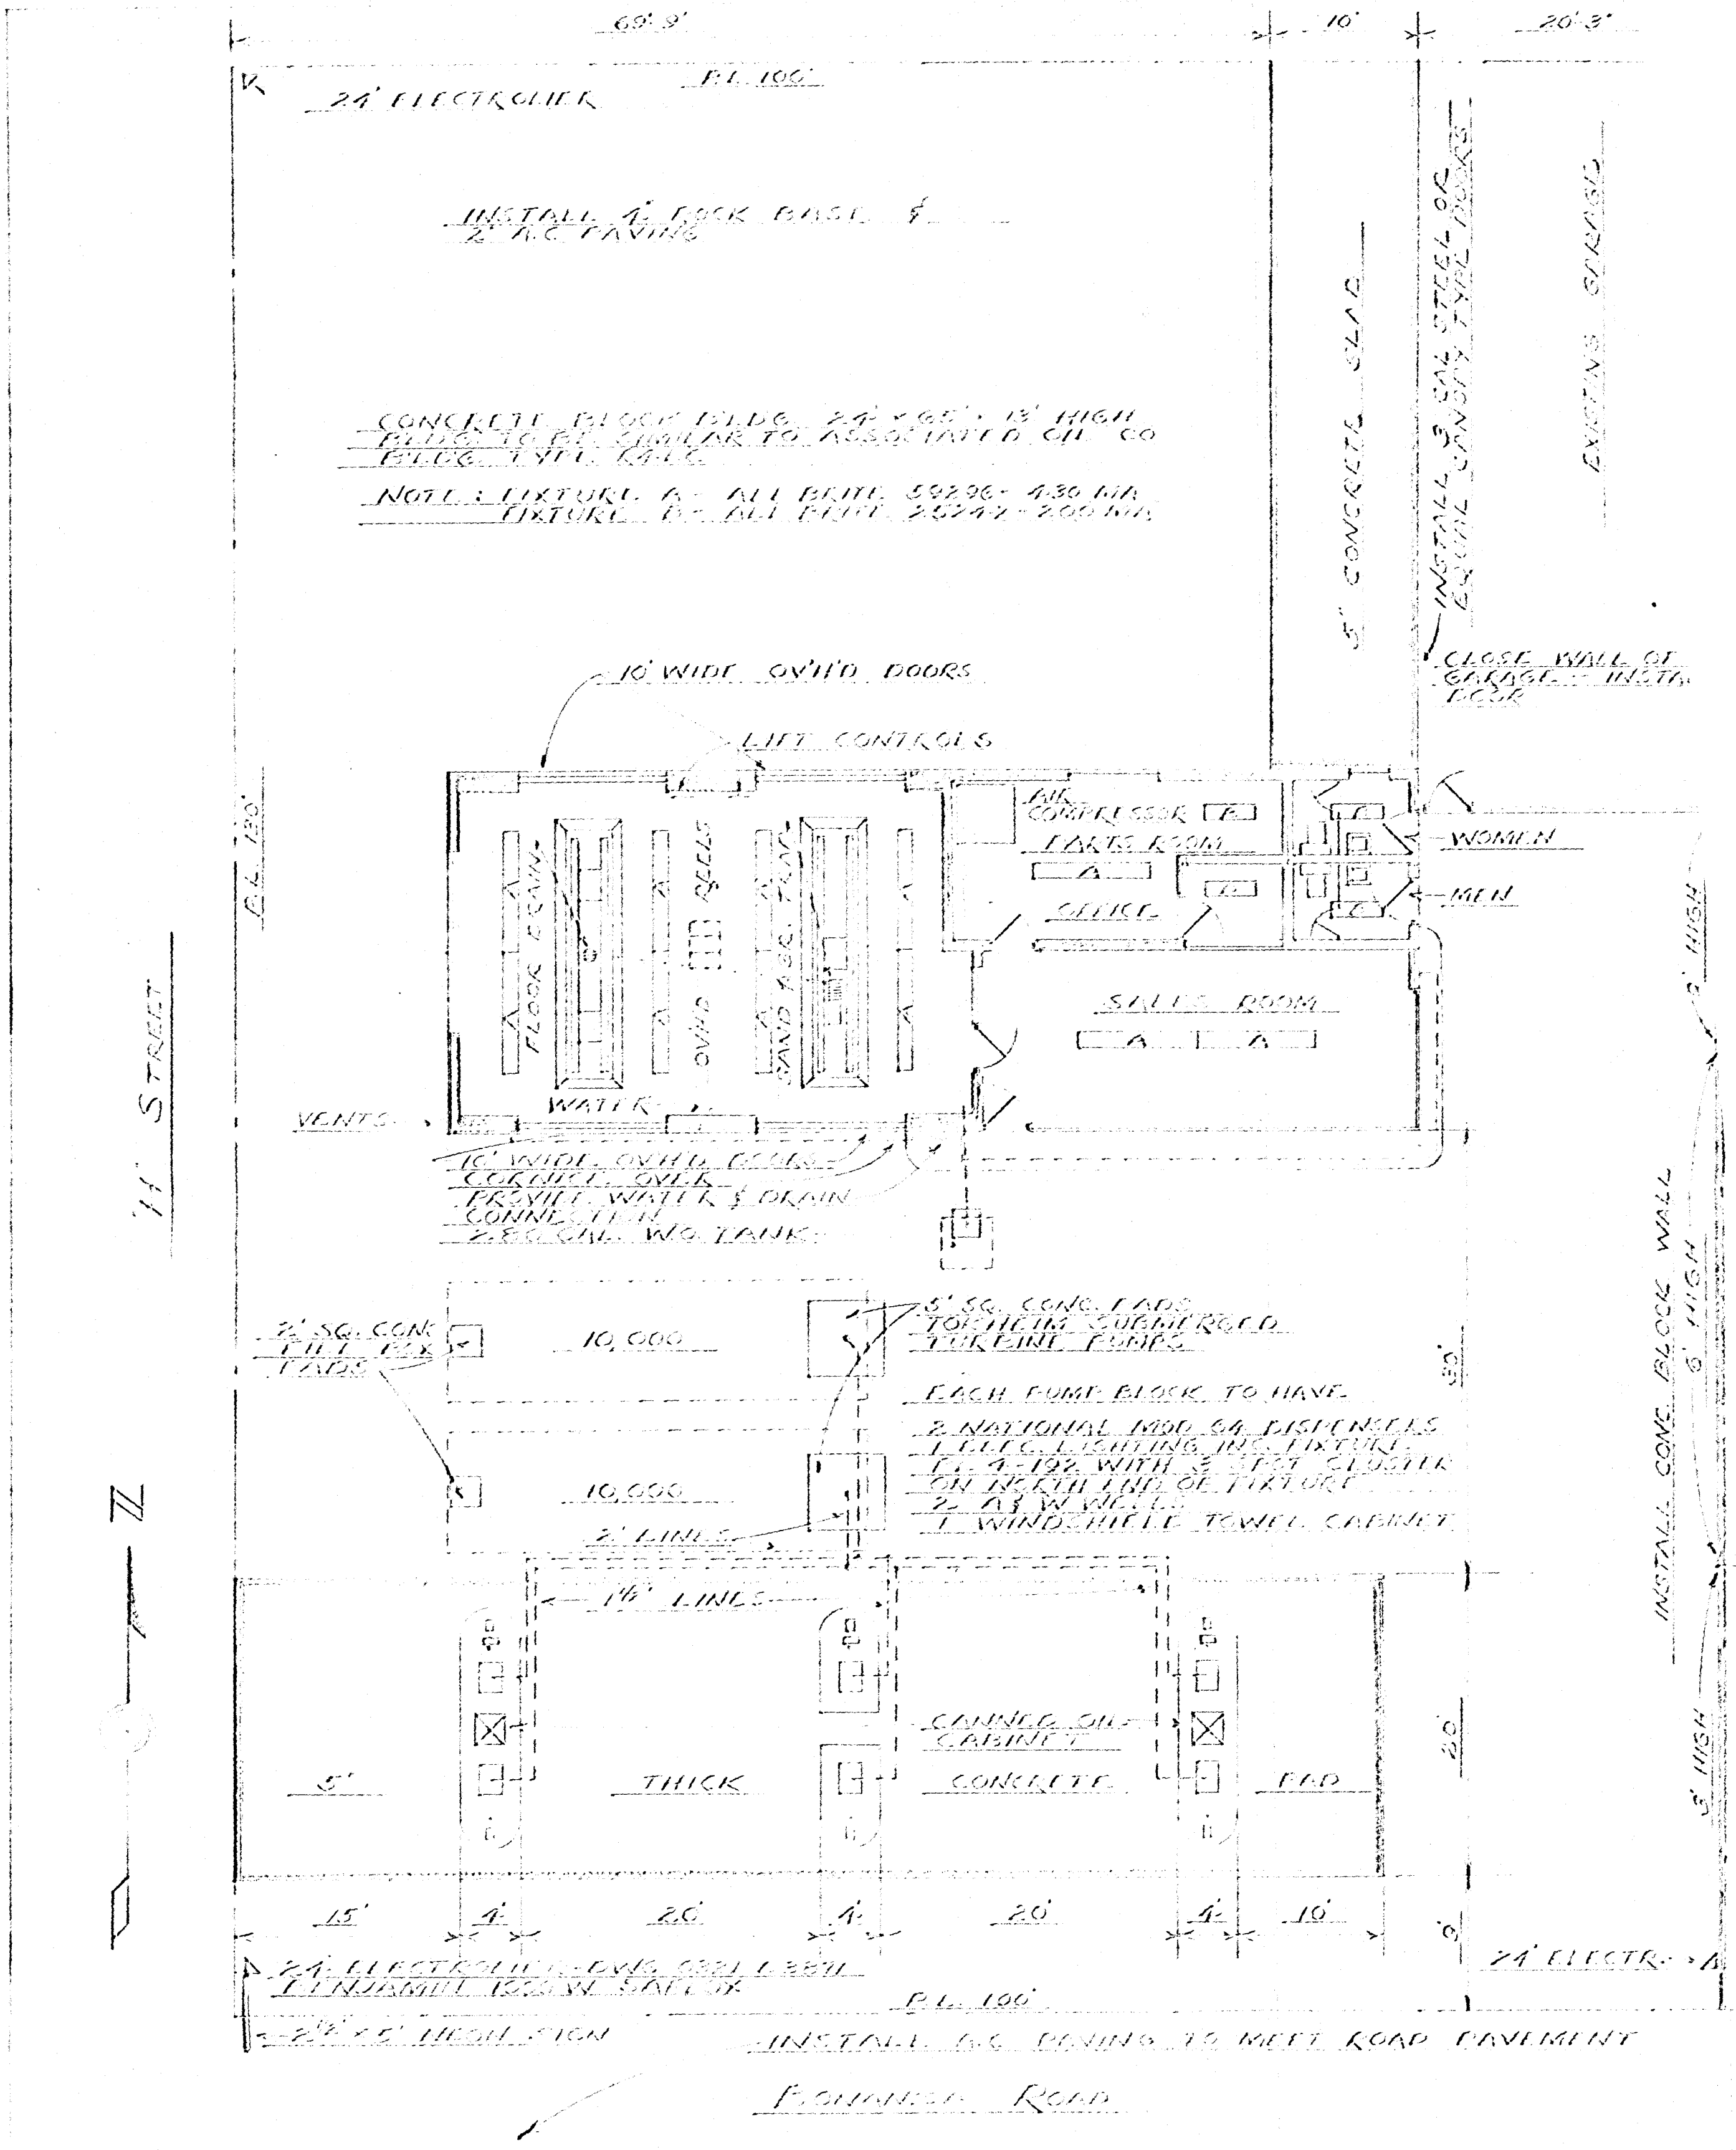


PROPOSED REMODEL
 L.V. CLEMENT SERV. ST
 BONDWAY RD & H ST
 LAS VEGAS, NEVADA
 RTH 48-187
 9/10/53 L.A. 53-1

ACCOMPANYING DRAWINGS	
NUMBER	TITLE

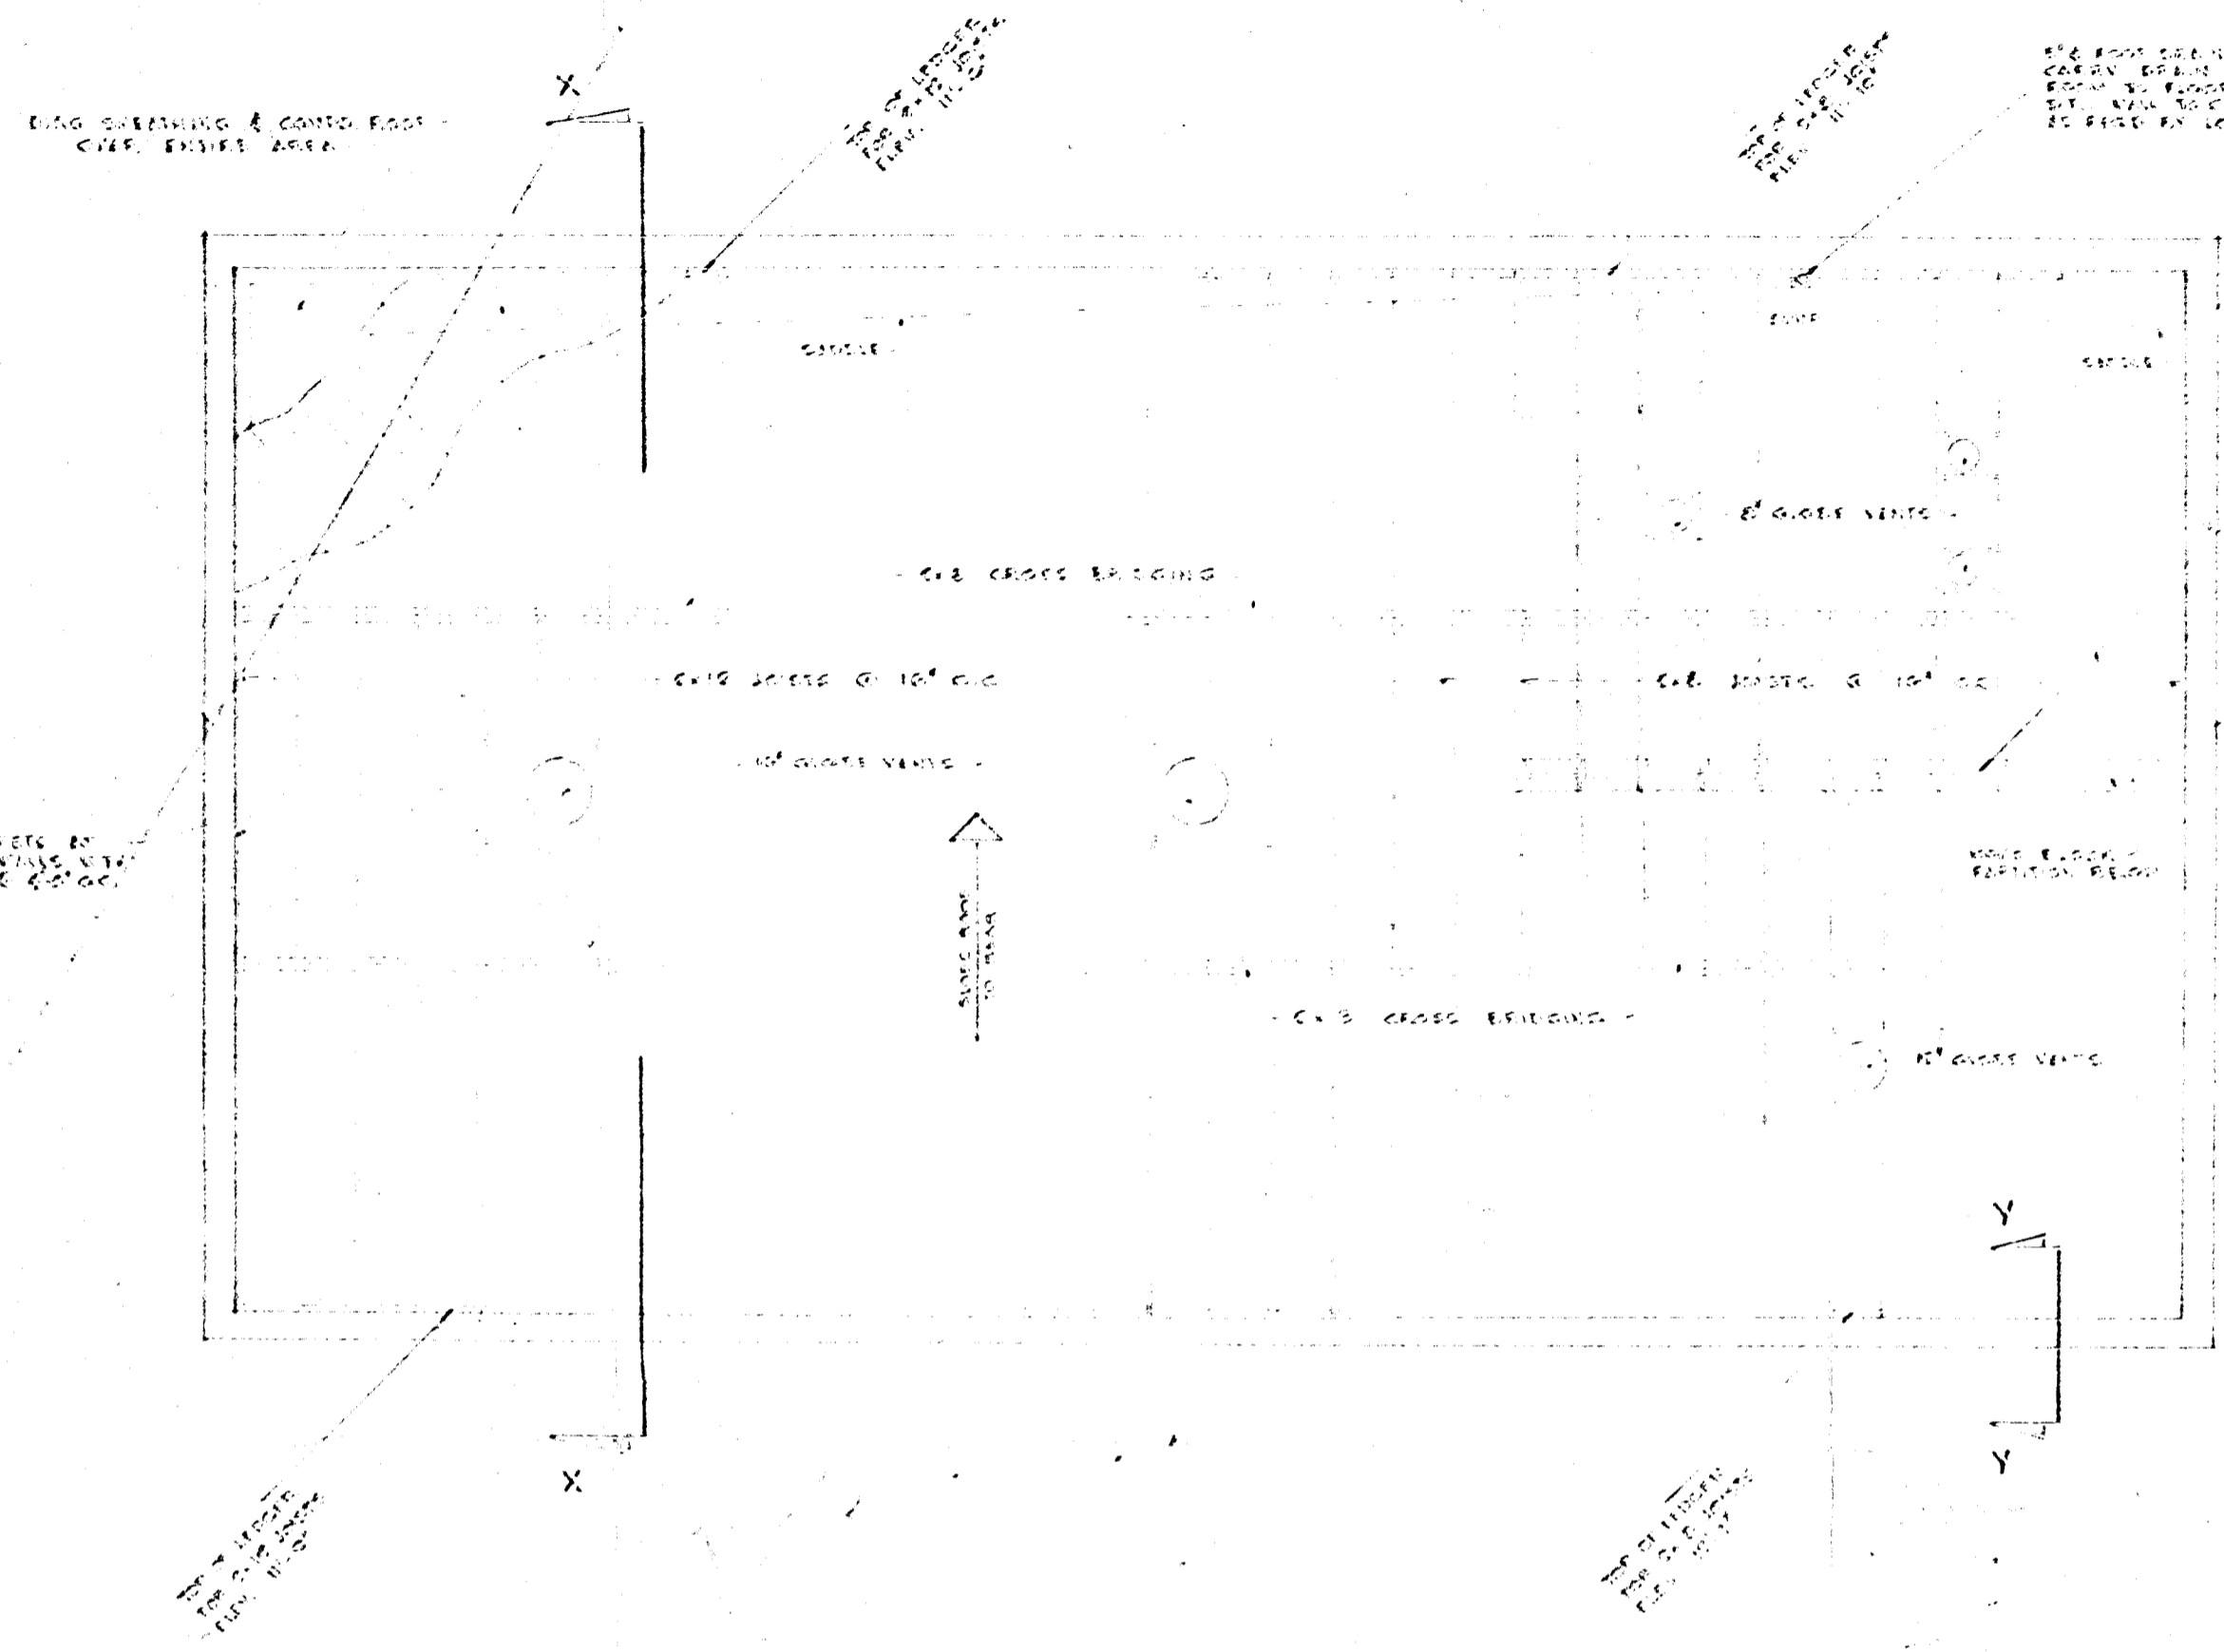


ROOF & ROOF FRAMING PLAN
SCALE 1/4" = 1'-0"


NOTE --
TO BE RIGHT OR LEFT HAND AS SHOWN
ON GENERAL ARCH'T. DWG.

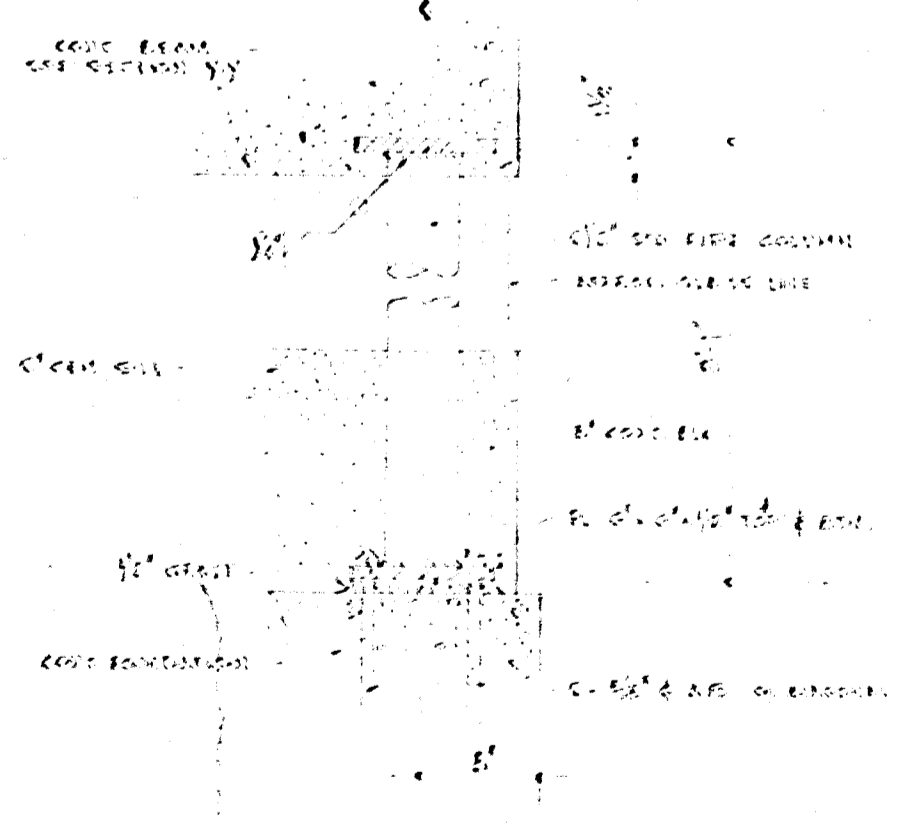


SALES ROOM PIPE COLUMN DETAIL
SCALE 1/2" = 1'-0"

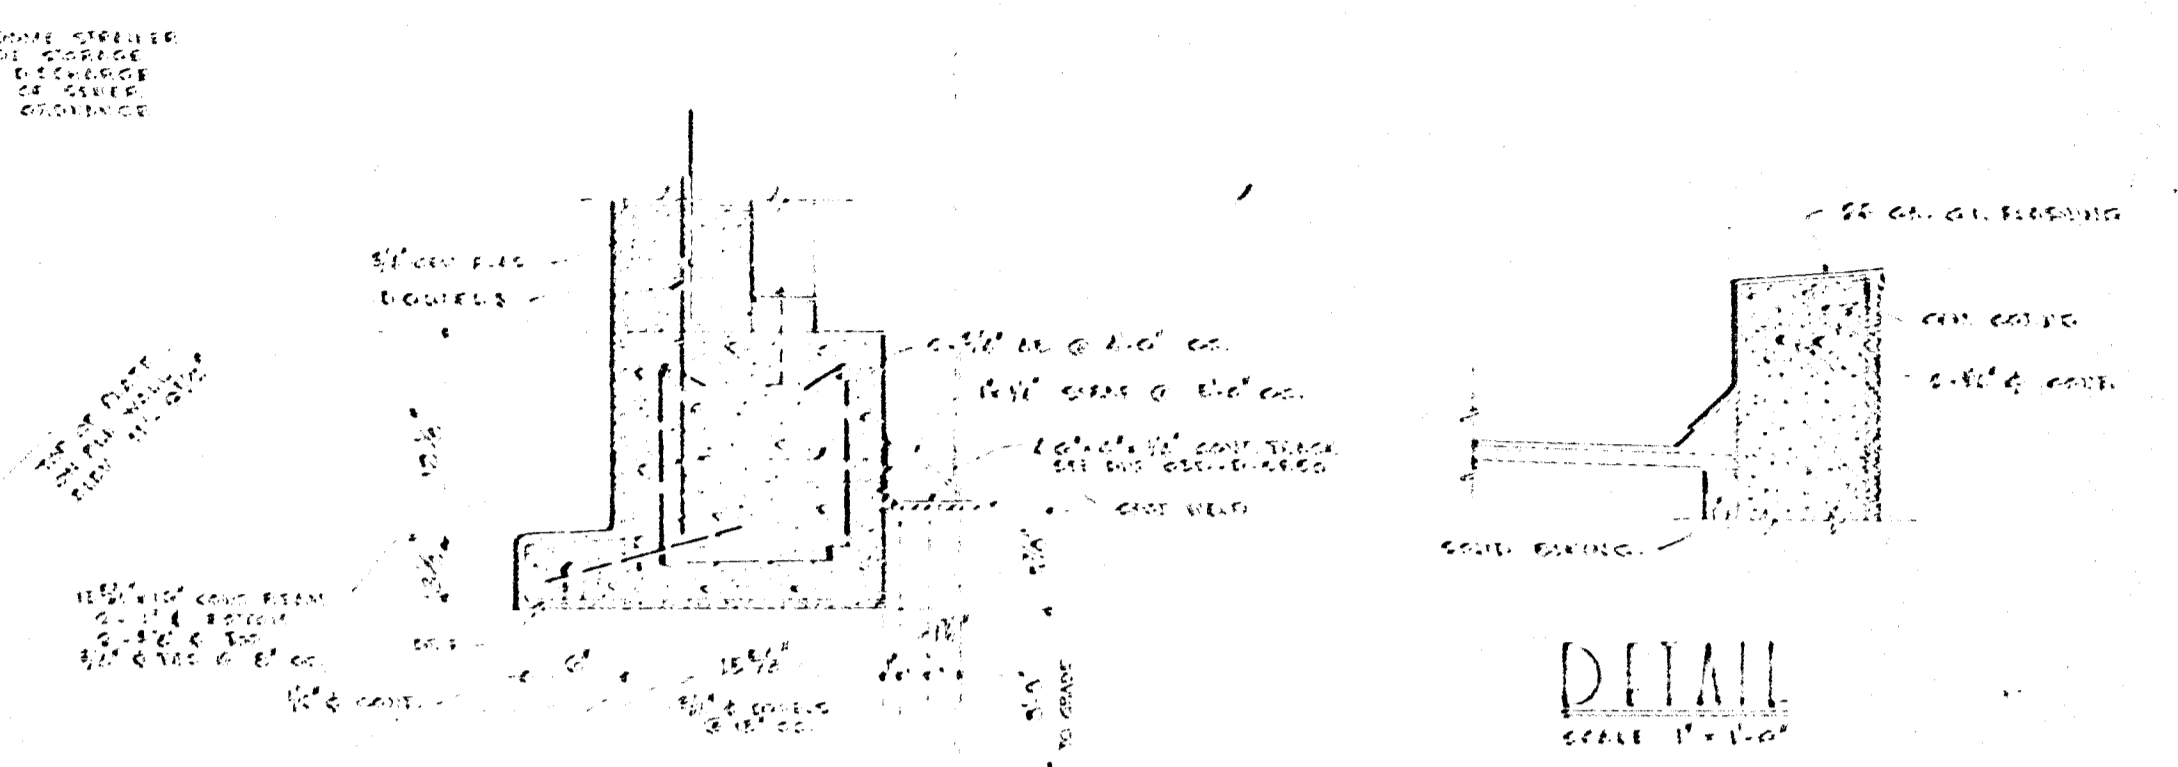


DETAIL
SCALE 1" = 1'-0"

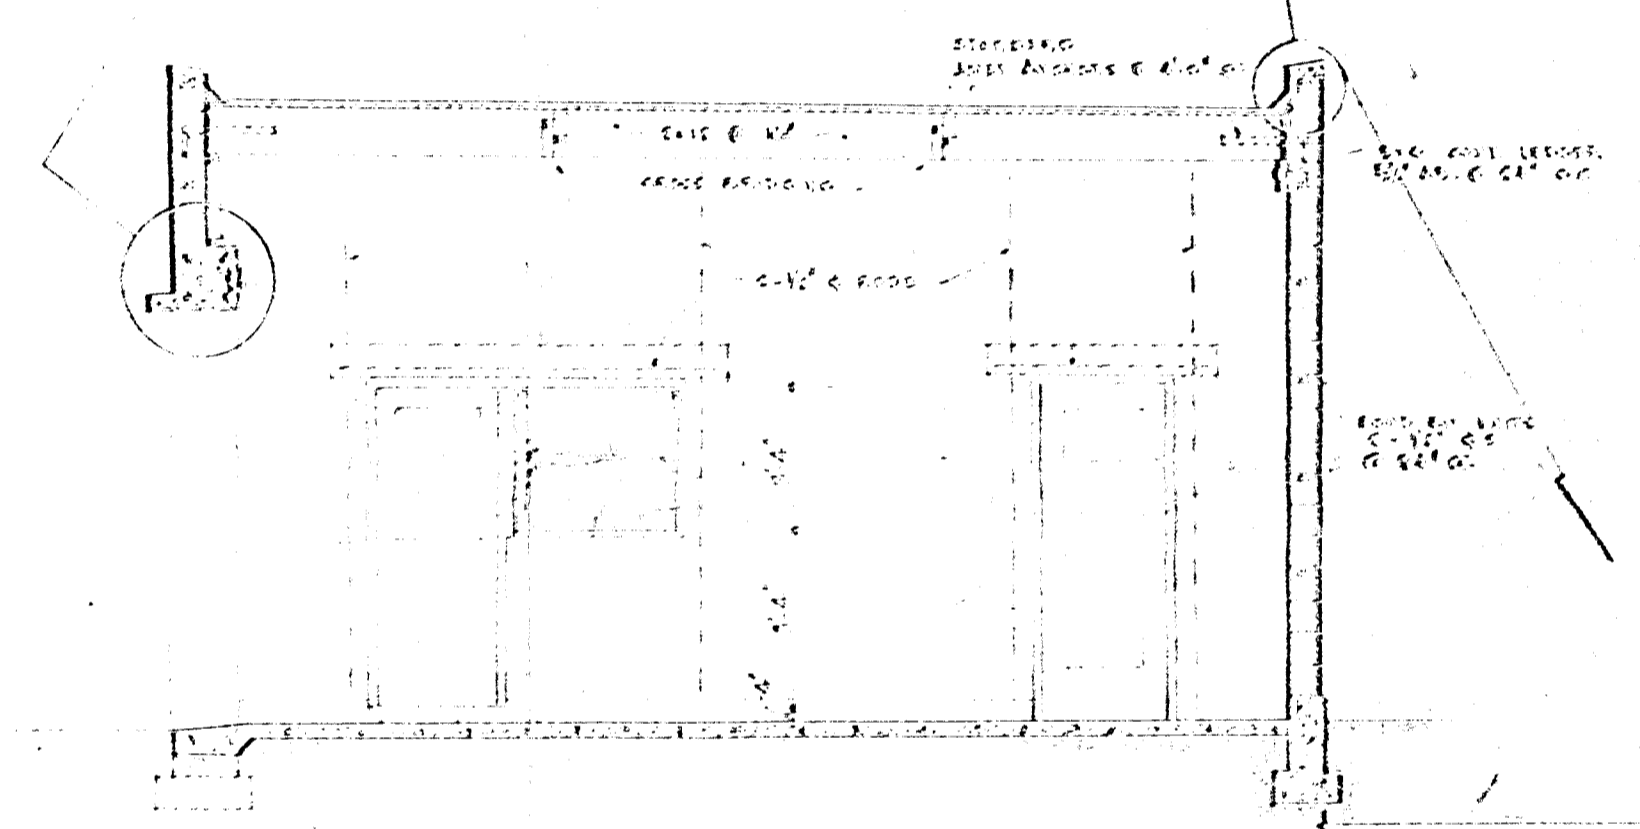


SECTION 'Y-Y'
SCALE 1/2" = 1'-0"

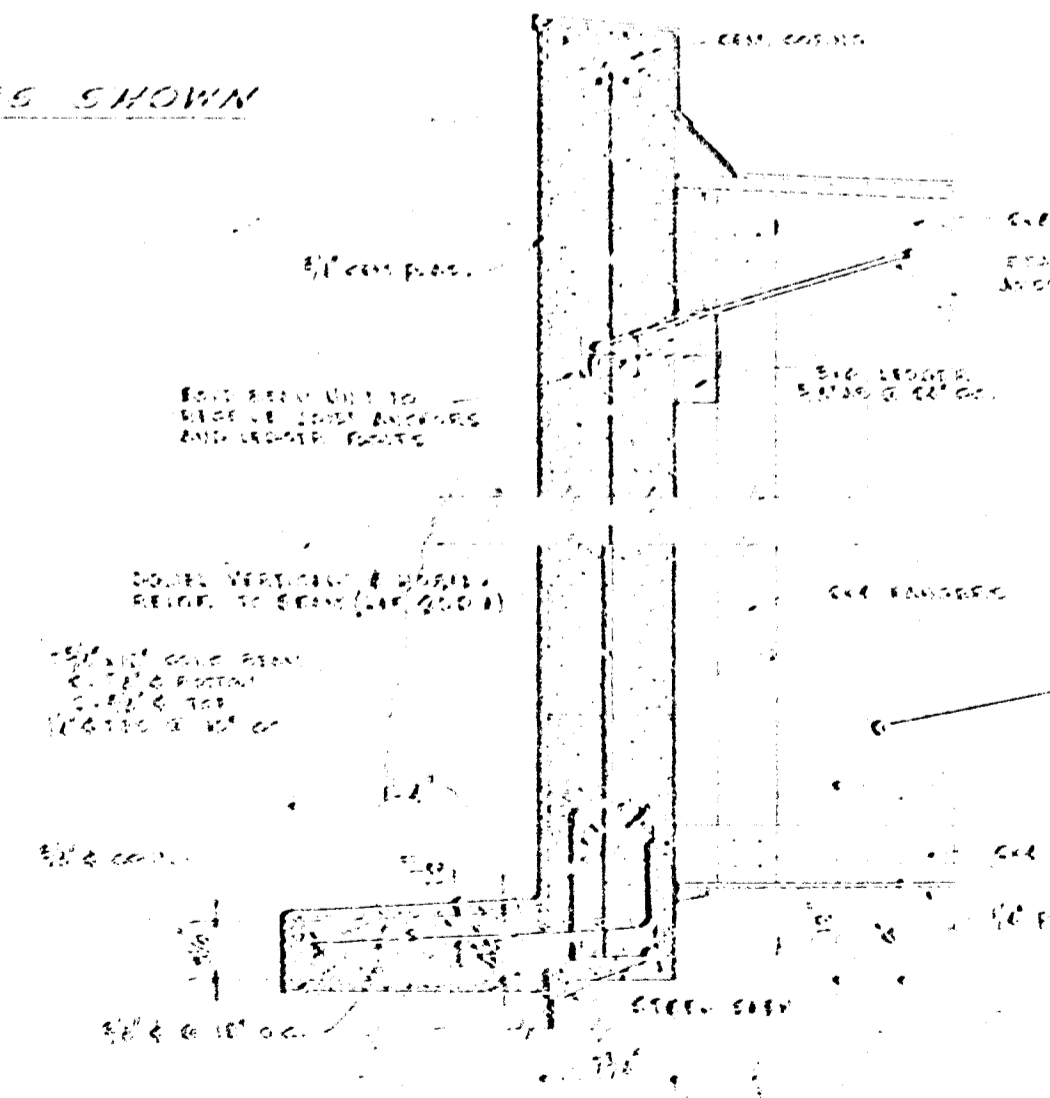

SECTION 'Y-Y'
SCALE 1" = 1'-0"

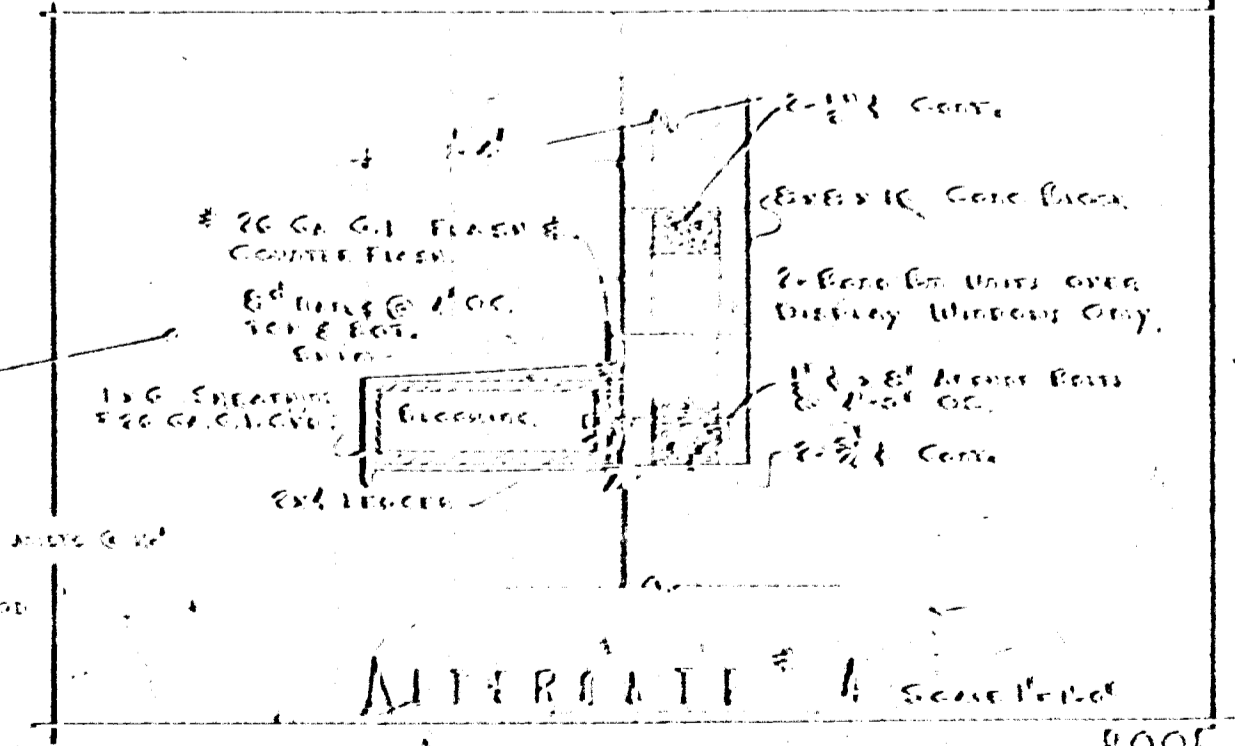

ALTERNATE # 4 Same as 1

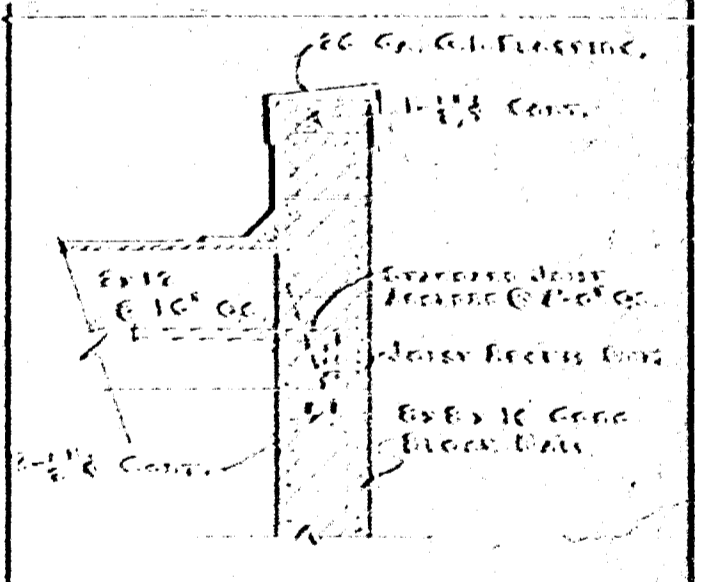

ALTERNATE # 3 Same as 1
Use Jolly Beams Units in Line of Beams

ROOF JOIST FRAMING DETAILS

TIDE WATER ASSOCIATED OIL CO.		CALIFORNIA	
SAN FRANCISCO		CALIFORNIA	
TYPE R.C. CONCRETE WALLS			
LEFT HAND SIDE			
DATE	APPROVED	SCALE	DRAWN BY
11-16-51		1/2" = 1'-0"	OSM-D-138

W. H. HANNEY
ARCHITECT
SAN FRANCISCO, CALIF.