





NOTE:  
ALL OFFSETS ARE  
TO BC UNLESS  
OTHERWISE NOTED

NOTE:  
SEE SHEET DT-02 FOR INTERSECTION DETAIL.  
SEE SHEETS SE-01 TO SE-02 FOR TYPE II SLURRY SEAL  
INSTALLATION LIMITS ALONG WASHINGTON AVENUE AND  
TENAYA WAY.

CURVE TABLE			
CURVE	LENGTH	RADIUS	DELTA
C9	39.72	25.00	91°01'42"
C10	38.65	25.00	88°35'10"
C11	38.67	25.00	88°37'02"
C12	39.58	25.00	90°42'36"

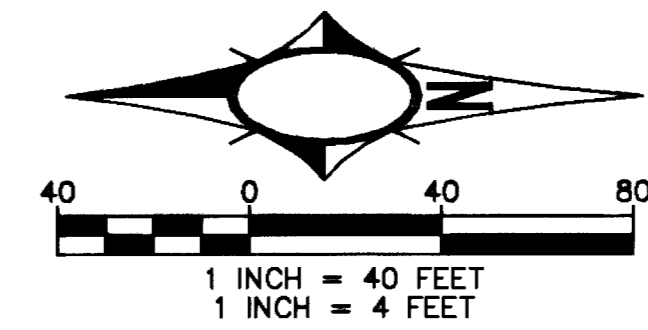

- ### CONSTRUCTION NOTES
- PROTECT-IN-PLACE
  - CONSTRUCT TYPE II SLURRY SEAL
  - CONSTRUCT UTACS AND PLANTMIX BITUMINOUS SURFACE WITH TYPE II AGGREGATE BASE, SEE TYPICAL SECTIONS
  - CONSTRUCT ADJUSTED TYPE "L" CURB AND GUTTER PER DETAIL ON SHEET DT-04
  - CONSTRUCT TYPE "L" CURB AND GUTTER PER USDCCA DWG NO. 216
  - CONSTRUCT 4-FOOT CROSS GUTTER PER DETAIL ON SHEET DT-04
  - CONSTRUCT 2.5-FOOT CROSS GUTTER PER DETAIL ON SHEET DT-04
  - CONSTRUCT TACK ON ISLAND MEDIAN PER USDCCA DWG NO. 220
  - CONSTRUCT CONCRETE SIDEWALK PER USDCCA DWG NO. 234
  - CONSTRUCT SIDEWALK RAMP PER USDCCA DWG NO. 235
  - NOT USED
  - CONSTRUCT CURBED SIDEWALK PER DETAIL 6 ON SHEET DT-04
  - RECONSTRUCT SIDEWALK RAMP WITH CAST-IN-PLACE DETECTABLE WARNING PANELS PER USDCCA NO. 235
  - CONSTRUCT TYPE "A" ISLAND CURB PER USDCCA DWG NO. 219
  - NOT USED
  - CONSTRUCT CONCRETE CROSS GUTTER PER USDCCA DWG NO. 228
  - CONSTRUCT COMMERCIAL DRIVEWAY PER USDCCA DWG NO. 224
  - INSTALL SURFACE APPLIED DETECTABLE WARNING PANELS PER USDCCA NO. 235
  - INSTALL 2 12-FOOT SWING GATES PER DETAIL 1, DT-04
  - CONSTRUCT PLANTMIX BITUMINOUS SURFACE WITH TYPE II AGGREGATE BASE, SEE TYPICAL SECTIONS
  - NOT USED
  - ADJUST SANITARY SEWER MANHOLE GRADE RINGS TO FINAL GRADE
  - ADJUST WATER METER & RPPA TO FINAL GRADE
  - ADJUST WATER VALVE BOX TO FINAL GRADE PER LVVWD PLATE 8
  - RELOCATE EXISTING WATER METER & RPPA PER LVVWD PLATE 1 ACCT # 524556 SEE SHEET UT-01 FOR DETAILS
  - NOT USED
  - NOT USED
  - NOT USED
  - NOT USED
  - NOT USED
  - CONSTRUCT CAST-IN-PLACE CANTILEVER RETAINING WALL SEE SHEET W-07 AND W-08
  - CONSTRUCT MSE WALL NO. 1 PER SHEET W-02
  - CONSTRUCT MSE WALL NO. 2 PER SHEET W-03
  - CONSTRUCT MSE WALL NO. 3 PER SHEET W-04
  - CONSTRUCT MSE WALL NO. 4 PER SHEET W-05
  - CONSTRUCT WEST MSE WALL CAP, SIDEWALK, BARRIER RAIL, AND CMU WALL PER SHEET W-06
  - CONSTRUCT EAST MSE WALL CAP, SIDEWALK, BARRIER RAIL, AND PEDESTRIAN RAIL PER SHEET W-06
  - PROTECT-IN-PLACE ACCESS KEYPAD PEDESTAL AND BOLLARD
  - INSTALL 72" CHAIN-LINK FENCE PER USDCCA DWG NO. 252
  - CONSTRUCT CMU WALL (MATCH EXISTING WALL) SEE DETAIL 7, SHEET DT-04

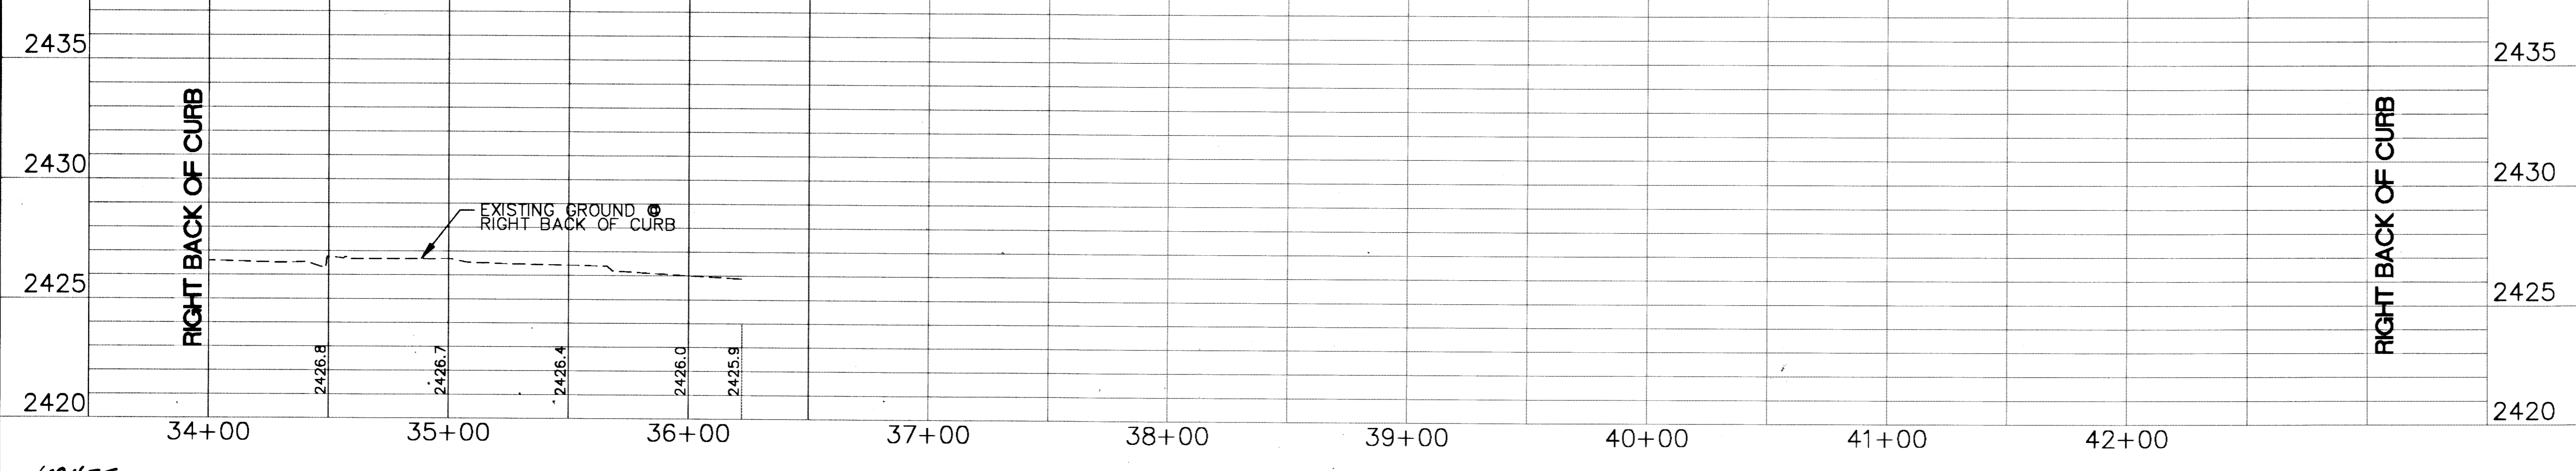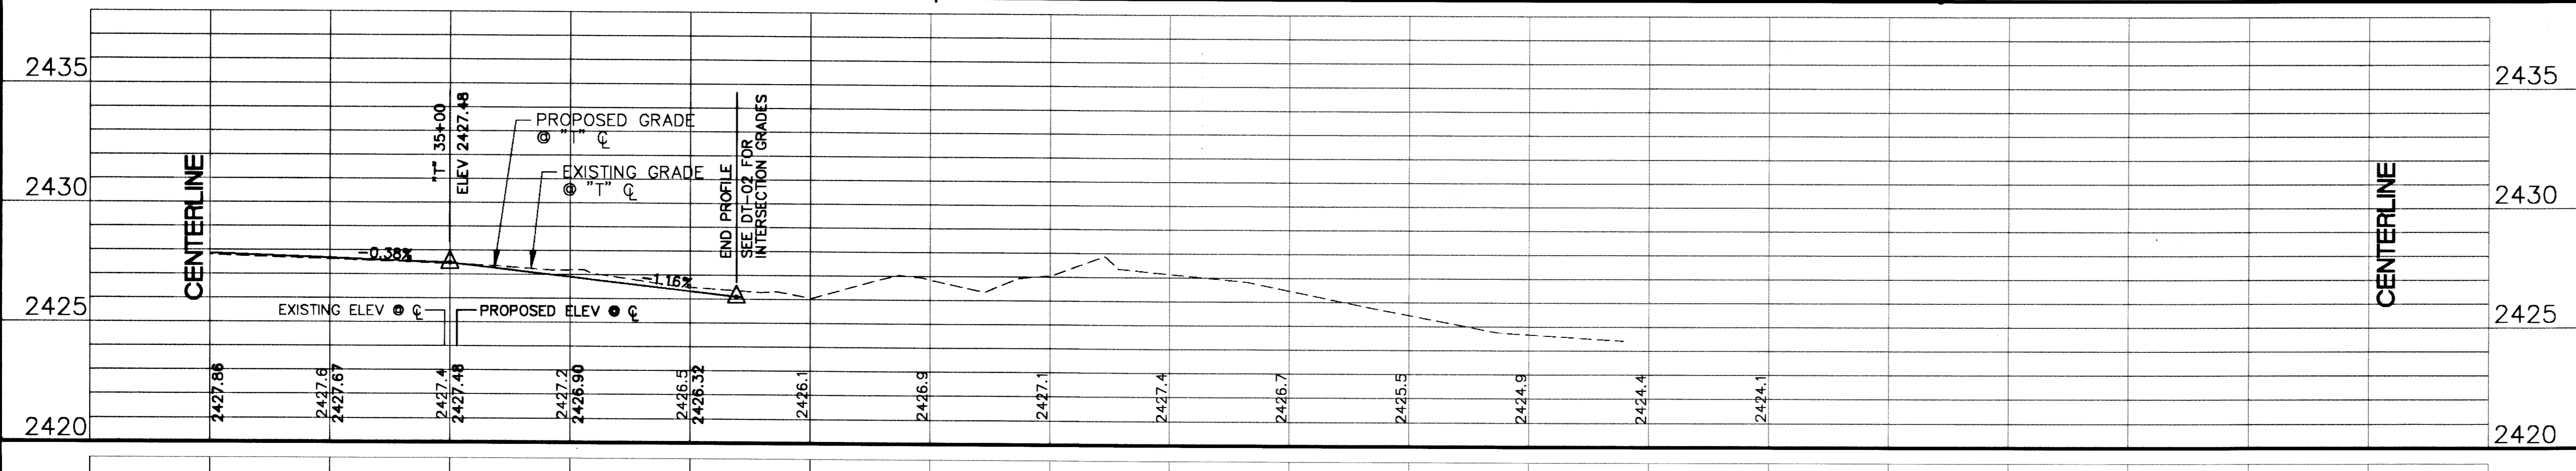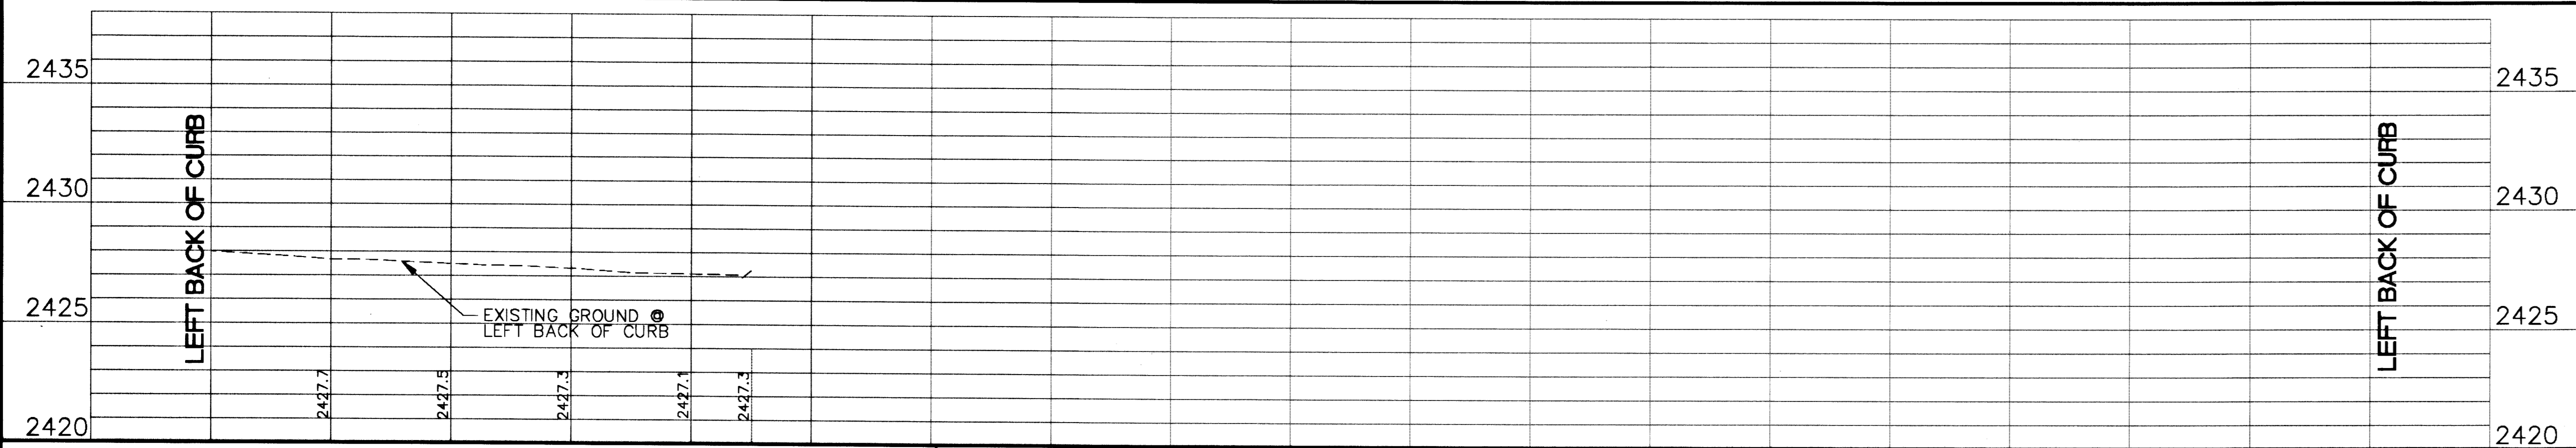

NO.	DATE	DESCRIPTION	APP'D

DEPARTMENT OF PUBLIC WORKS  
ENGINEERING DESIGN SECTION

CITY ENGINEER: JORGE CERVANTES, P.E.  
PROGRAM MANAGER: MARK SORENSEN, P.E.

DESIGNED BY: RSM  
DRAWN BY: ESM  
CHECKED BY: HDR Engineering, Inc.

HDR

HORIZONTAL SCALE: 1"=40'  
VERTICAL SCALE: 1"=4'

DATE: 1/2008

TENAYA WAY OVERPASS  
AT SUMMERLIN PKWY  
PLAN AND PROFILE  
STA 34+00 TO STA 42+00

LAS VEGAS VALLEY WATER DISTRICT  
DATE: 1-22-08  
SEE SHEET GN-01 FOR LVVWD STANDARD NOTES

### LEGEND

- UTACS AND PLANTMIX BITUMINOUS SURFACE
- TYPE II SLURRY SEAL
- PLANTMIX BITUMINOUS SURFACE

SAFETY ALERT  
Call before you Dig  
Call before you Overhead

TITLE: SHEET: 1/23/08

RUSSELL S. MCNAUGHT  
Em. 12/1/04  
CIVIL

Sheet PP-04  
12 of 96  
DRAWING NO. 107Y4452

P:\Tenaya\Sheets\PP-004.dwg 01/18/08 7:26am abdo

109455