

CRESTDALE LANE

SCALE: HORIZ. 1" = 20'
VERT. 1" = 5'

*NOTE: APPROVAL OF THESE PLANS FOR THE STUBOUT INSTALLATION WILL NOT BE CONSTRUED AS A COMMITMENT FOR WATER SERVICE TO THIS PROPERTY.
CURVED SEWER NOTE: LINE & GRADE STAKES TO BE PROVIDED AT 25' MAX. INTERVALS.

CURVE DATA (1 INDICATES CURVE NUMBER)

NO.	DELTA	RADIUS	LENGTH	TANGENT
1	01°32'55"	1064.00'	28.76'	14.38'
2	08°19'14"	500.00'	72.61'	36.37'
3	05°50'29"	1070.00'	109.09'	54.59'
4	15°42'38"	1100.00'	301.62'	151.76'
5	03°12'29"	526.00'	29.45'	14.73'
6	09°54'23"	1130.00'	195.38'	97.93'

NOTE: CURVE DATA REPRESENTS PARTIAL CURVE, THIS SHEET ONLY.



CONSTRUCTION NOTES

- IMPROVEMENTS**
- (1) INSTALL "L" TYPE CURB & GUTTER (S-47 S)
 - (2) INSTALL AC PAVEMENT PER STREET SECTIONS SHEET NO. 18

- SEWER**
- (1) INSTALL 8" SEWER PIPE (J-20 S)
 - (2) INSTALL SEWER MANHOLE (SD1-8 CLV)

- WATER**
- (1) INSTALL 12" WATER PIPE (J-20 S)
 - (2) INSTALL 8" WATER PIPE (J-20 S)
 - (3) INSTALL 8" WATER GATE VALVE (J-34 S)
 - (4) INSTALL TEMP. 2" BLOWOFF ASSEMBLY
 - (5) INSTALL 12" X 12" X 8" TEE

- STREET LIGHTING**
- (1) STREET LIGHT OR COMMON TRENCH, SEE ELECTRICAL PLANS
 - (2) INSTALL STREET LIGHT, SEE ELECTRICAL PLANS (E-2 S)

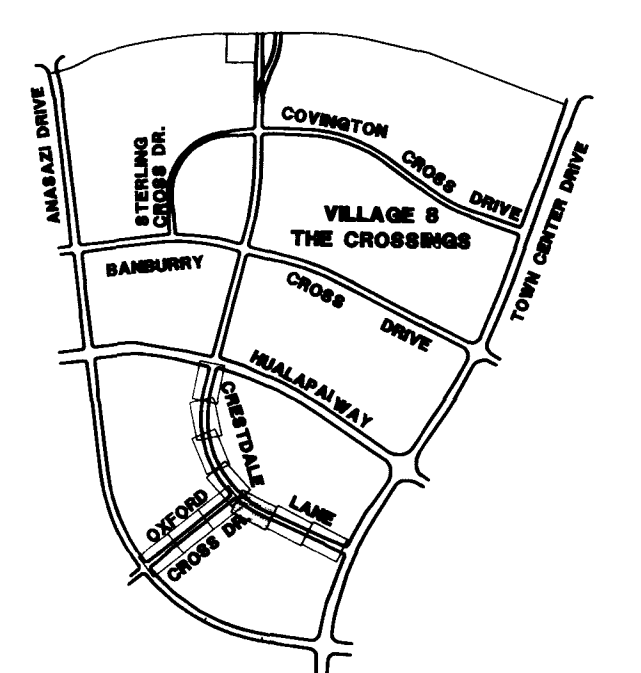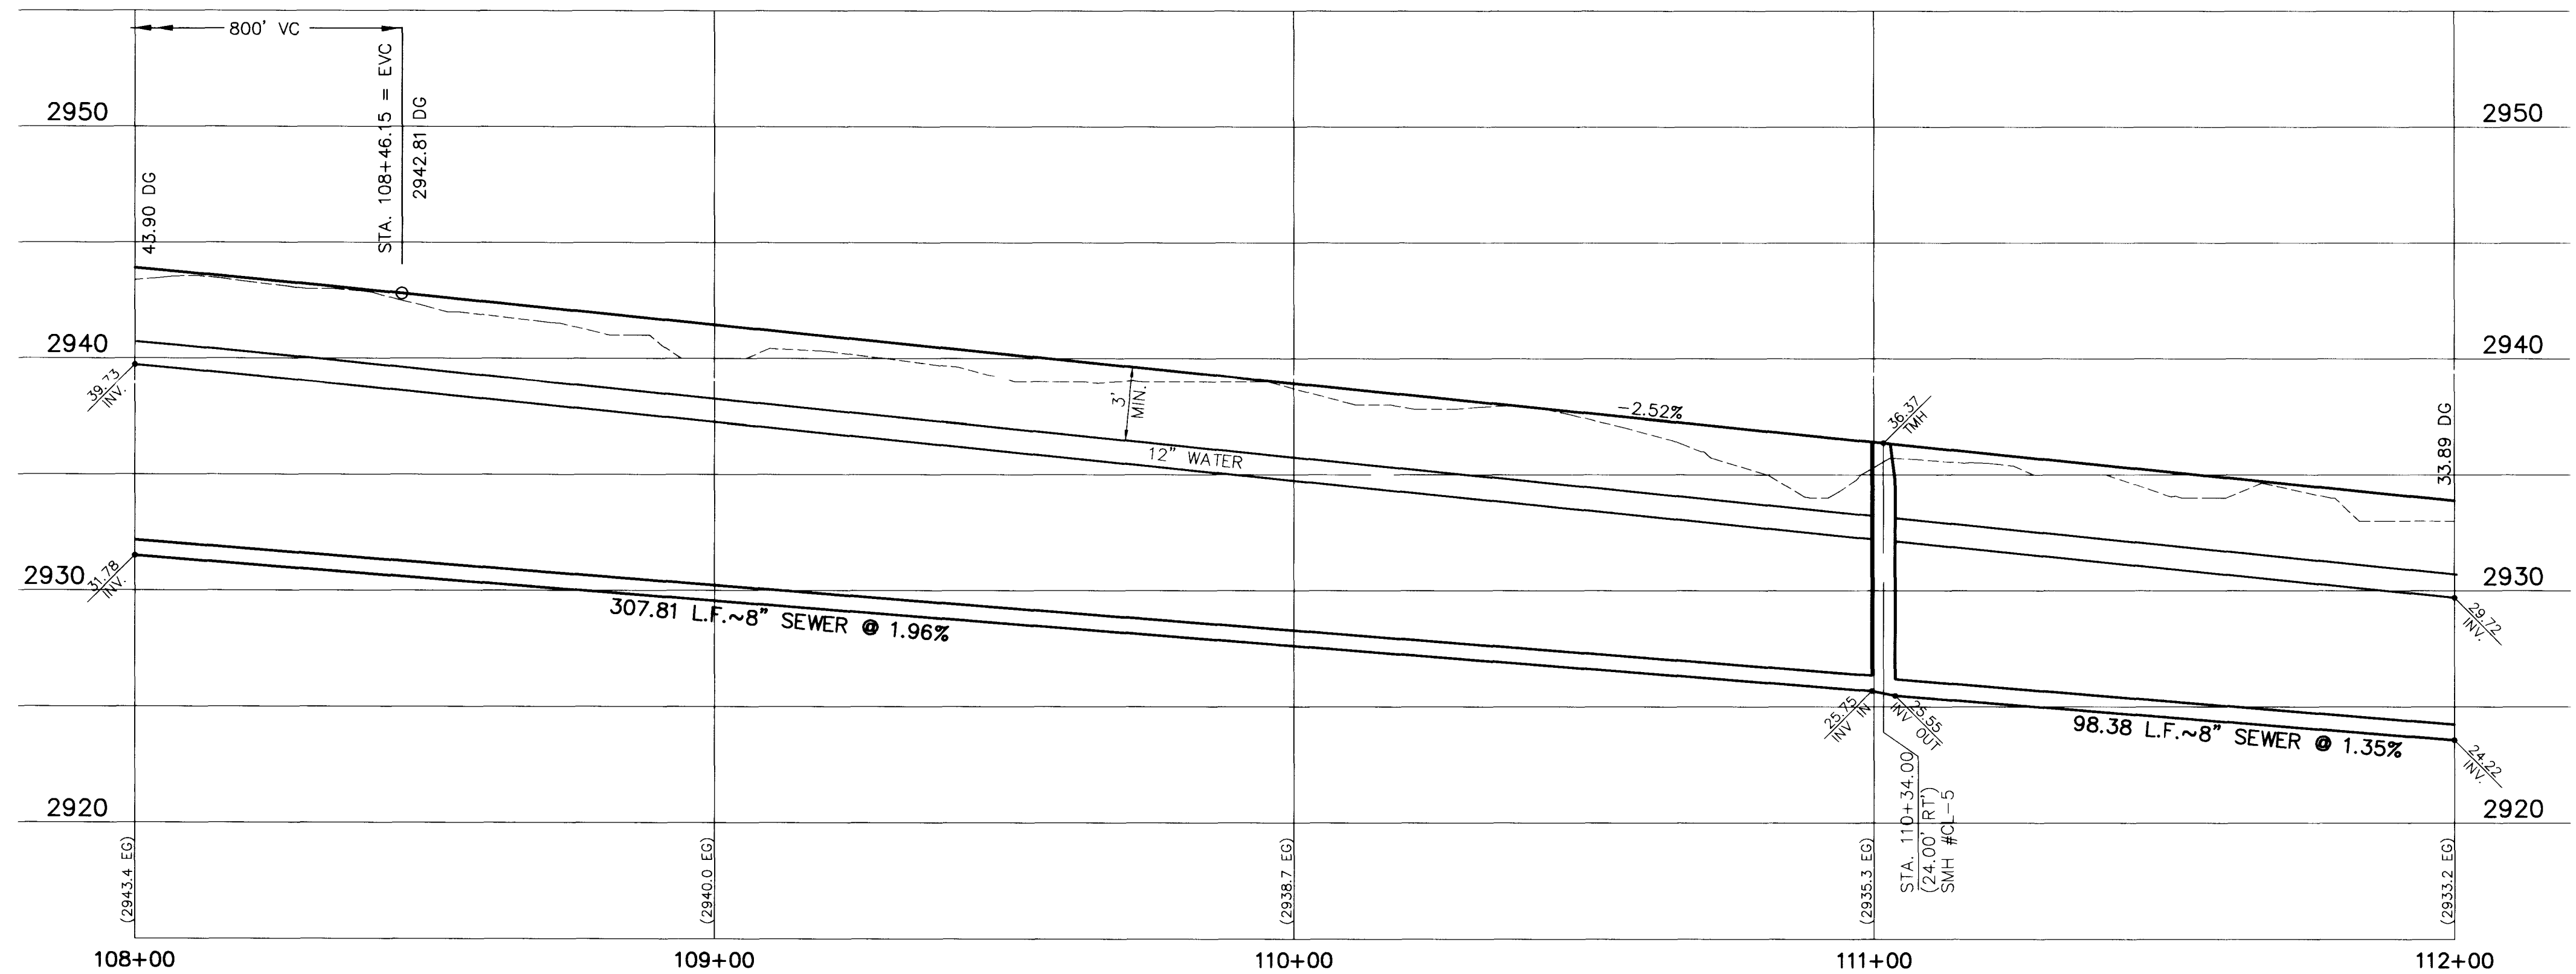

SHEET INDEX MAP

APPROVAL: _____
LAS VEGAS VALLEY WATER DISTRICT

ENGINEER: STATE OF NEVADA
REGISTERED PROFESSIONAL ENGINEER
BERT A. HUGHES
CIVIL
10258

G. C. WALLACE, INC.
Engineering/Architecture
1585 SOUTH HANDBY BLVD., LAS VEGAS, NEVADA 89102

SUMMERLIN VILLAGE 8 UNIT 3 IMPROVEMENTS
CRESTDALE LANE
PLAN & PROFILE
STA. 108+00 TO STA. 112+00


DATE: _____
APPROVAL: _____

SHEET **11** OF 20
SHT 11 OF 20


JOB NO. 62008.203

6.1.5, CP-5 DWG, 11/18/94

11-2-130 107-V2289

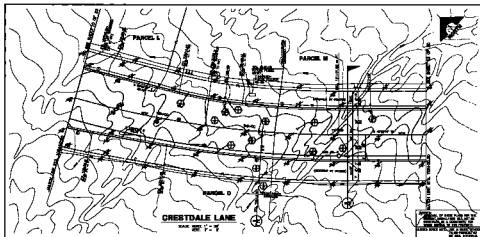

THIS MAP IS A REPRODUCTION OF THE ORIGINAL MAP ON FILE IN THE OFFICE OF THE COUNTY ENGINEER, COUNTY OF LOS ANGELES, CALIFORNIA. THE ORIGINAL MAP WAS FILED ON 11/15/1988. THE ORIGINAL MAP WAS DRAWN BY J. L. KALLACE, INC. AND IS BEING REPRODUCED FOR THE PURPOSES OF THIS PROJECT.

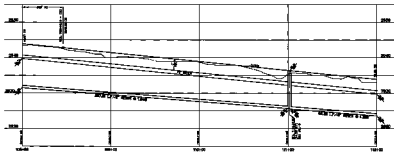

PROPOSED ROADWAY

Station	Width	Grade	Notes
10+00	40'	1%	
10+25	40'	1%	
10+50	40'	1%	
10+75	40'	1%	
11+00	40'	1%	
11+25	40'	1%	
11+50	40'	1%	
11+75	40'	1%	
12+00	40'	1%	

PROPOSED DRIVEWAY

Station	Width	Grade	Notes
10+00	10'	1%	
10+25	10'	1%	
10+50	10'	1%	
10+75	10'	1%	
11+00	10'	1%	
11+25	10'	1%	
11+50	10'	1%	
11+75	10'	1%	
12+00	10'	1%	

PROPOSED SIDEWALK

Station	Width	Grade	Notes
10+00	5'	1%	
10+25	5'	1%	
10+50	5'	1%	
10+75	5'	1%	
11+00	5'	1%	
11+25	5'	1%	
11+50	5'	1%	
11+75	5'	1%	
12+00	5'	1%	

PROPOSED UTILITY

Station	Depth	Notes
10+00	4'	
10+25	4'	
10+50	4'	
10+75	4'	
11+00	4'	
11+25	4'	
11+50	4'	
11+75	4'	
12+00	4'	

PROPOSED SIGNAGE

Station	Notes
10+00	
10+25	
10+50	
10+75	
11+00	
11+25	
11+50	
11+75	
12+00	

PROPOSED LIGHTING

Station	Notes
10+00	
10+25	
10+50	
10+75	
11+00	
11+25	
11+50	
11+75	
12+00	

PROPOSED LANDSCAPE

Station	Notes
10+00	
10+25	
10+50	
10+75	
11+00	
11+25	
11+50	
11+75	
12+00	

PROPOSED FENCE

Station	Notes
10+00	
10+25	
10+50	
10+75	
11+00	
11+25	
11+50	
11+75	
12+00	

PROPOSED CURB

Station	Notes
10+00	
10+25	
10+50	
10+75	
11+00	
11+25	
11+50	
11+75	
12+00	

PROPOSED DRAINAGE

Station	Notes
10+00	
10+25	
10+50	
10+75	
11+00	
11+25	
11+50	
11+75	
12+00	

PROPOSED UTILITIES

Station	Notes
10+00	
10+25	
10+50	
10+75	
11+00	
11+25	
11+50	
11+75	
12+00	

PROPOSED SIGNAGE

Station	Notes
10+00	
10+25	
10+50	
10+75	
11+00	
11+25	
11+50	
11+75	
12+00	

PROPOSED LIGHTING

Station	Notes
10+00	
10+25	
10+50	
10+75	
11+00	
11+25	
11+50	
11+75	
12+00	

PROPOSED LANDSCAPE

Station	Notes
10+00	
10+25	
10+50	
10+75	
11+00	
11+25	
11+50	
11+75	
12+00	

PROPOSED FENCE

Station	Notes
10+00	
10+25	
10+50	
10+75	
11+00	
11+25	
11+50	
11+75	
12+00	

PROPOSED CURB

Station	Notes
10+00	
10+25	
10+50	
10+75	
11+00	
11+25	
11+50	
11+75	
12+00	

PROPOSED DRAINAGE

Station	Notes
10+00	
10+25	
10+50	
10+75	
11+00	
11+25	
11+50	
11+75	
12+00	

PROPOSED UTILITIES

Station	Notes
10+00	
10+25	
10+50	
10+75	
11+00	
11+25	
11+50	
11+75	
12+00	

PROPOSED SIGNAGE

Station	Notes
10+00	
10+25	
10+50	
10+75	
11+00	
11+25	
11+50	
11+75	
12+00	

PROPOSED LIGHTING

Station	Notes
10+00	
10+25	
10+50	
10+75	
11+00	
11+25	
11+50	
11+75	
12+00	

PROPOSED LANDSCAPE

Station	Notes
10+00	
10+25	
10+50	
10+75	
11+00	
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PROPOSED FENCE

Station	Notes
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11+25	
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12+00	

PROPOSED CURB

Station	Notes
10+00	
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11+00	
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PROPOSED CURB

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PROPOSED DRAINAGE

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11+75	
12+00	

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