

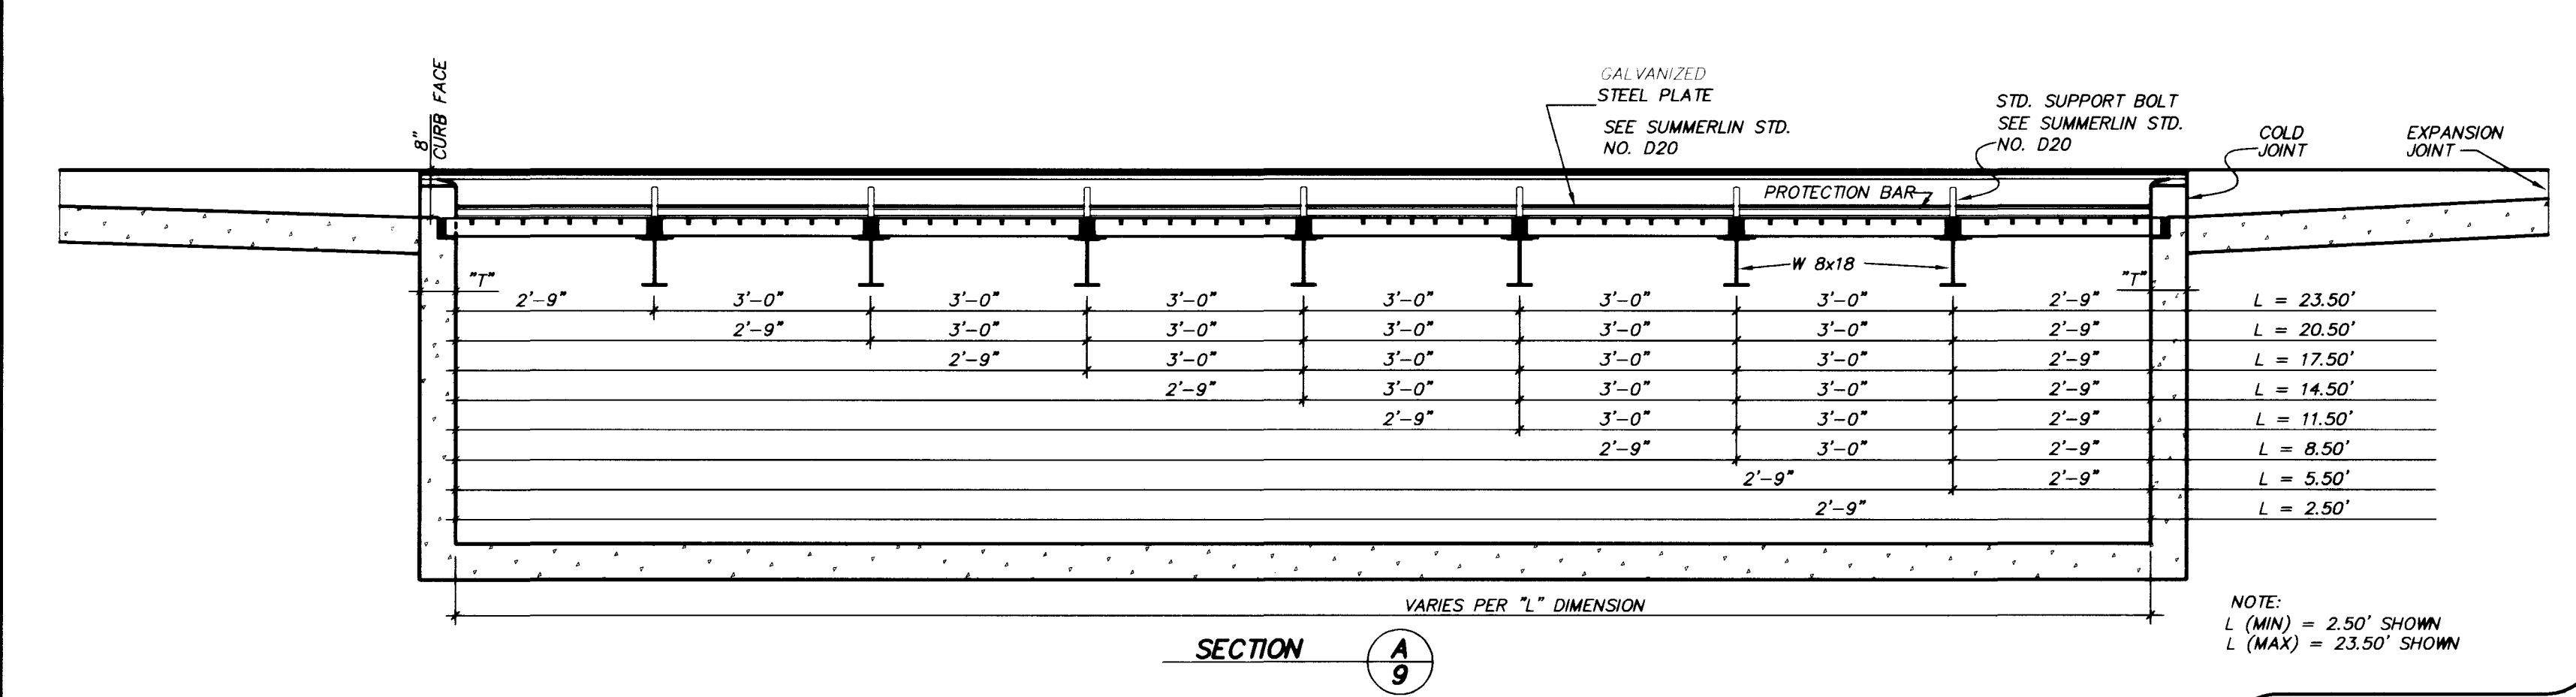
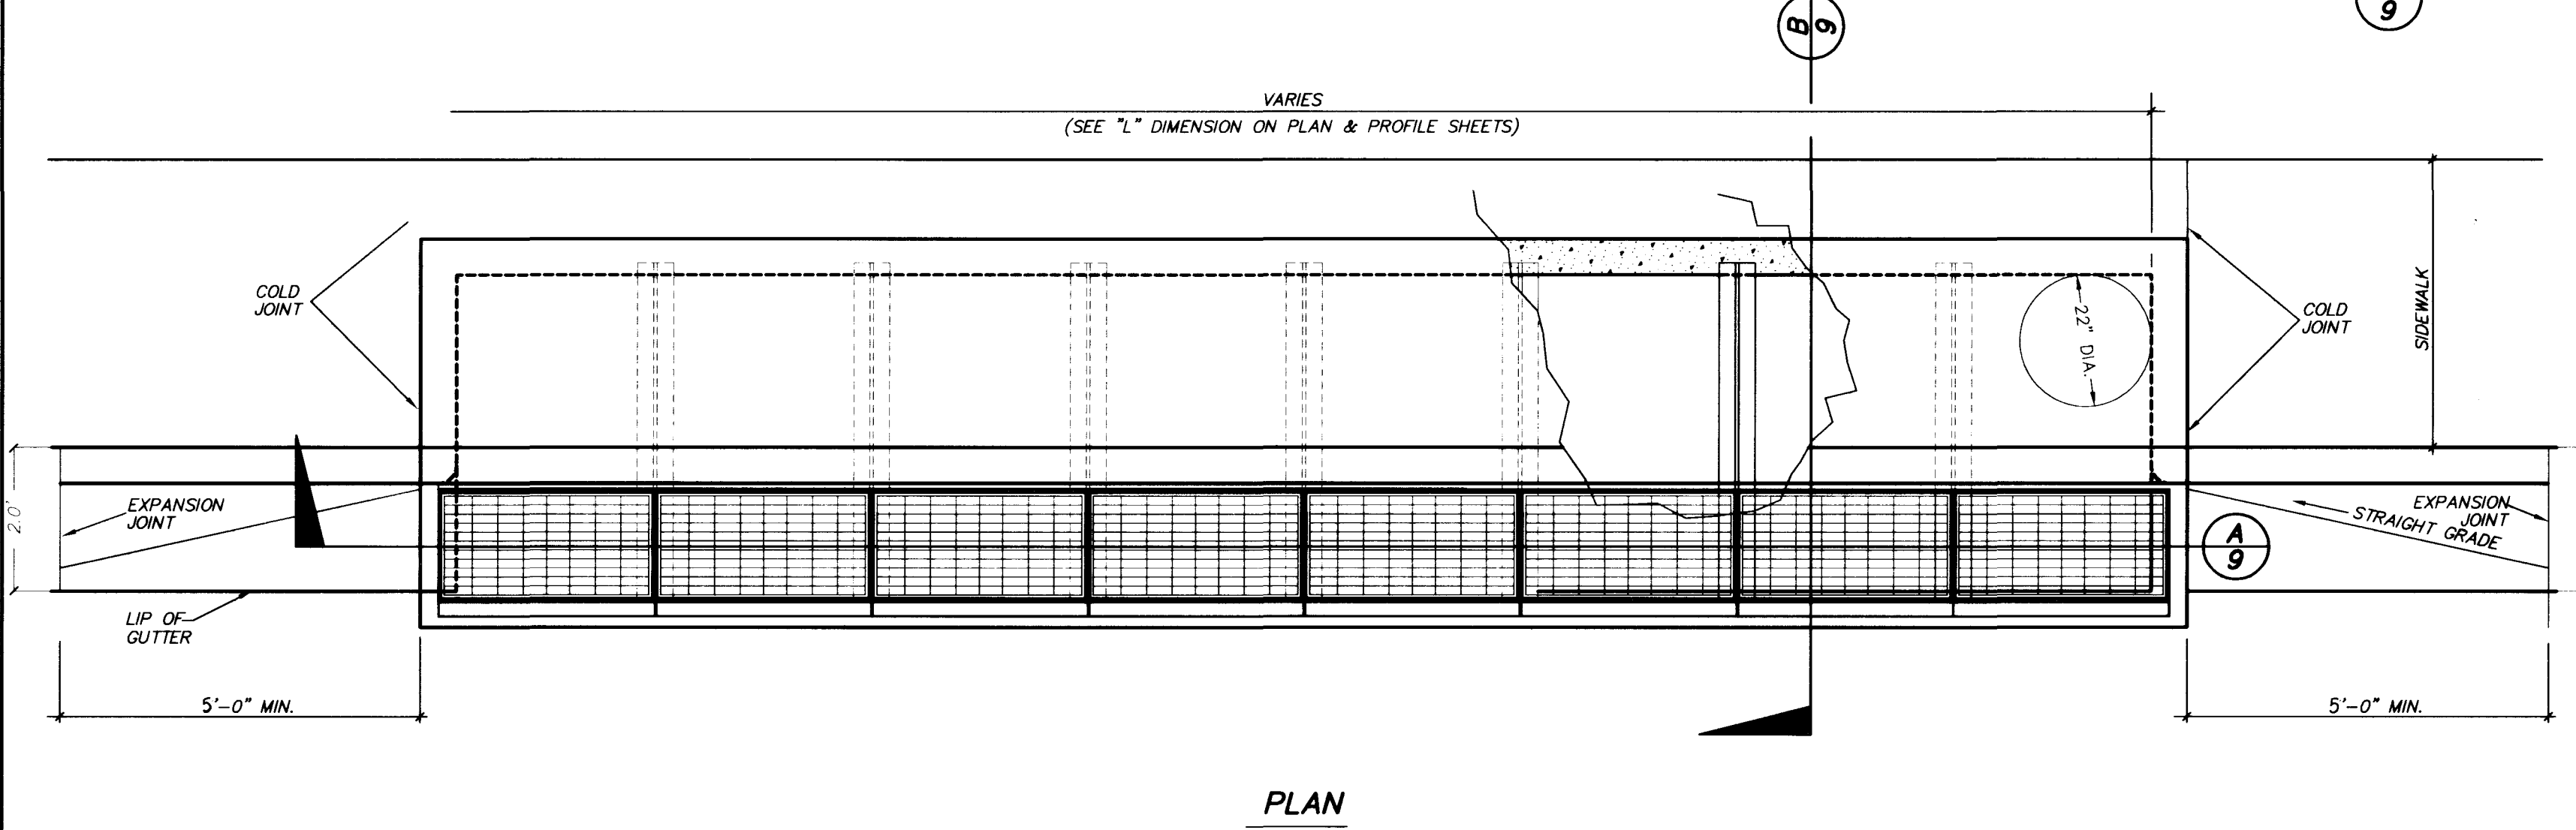
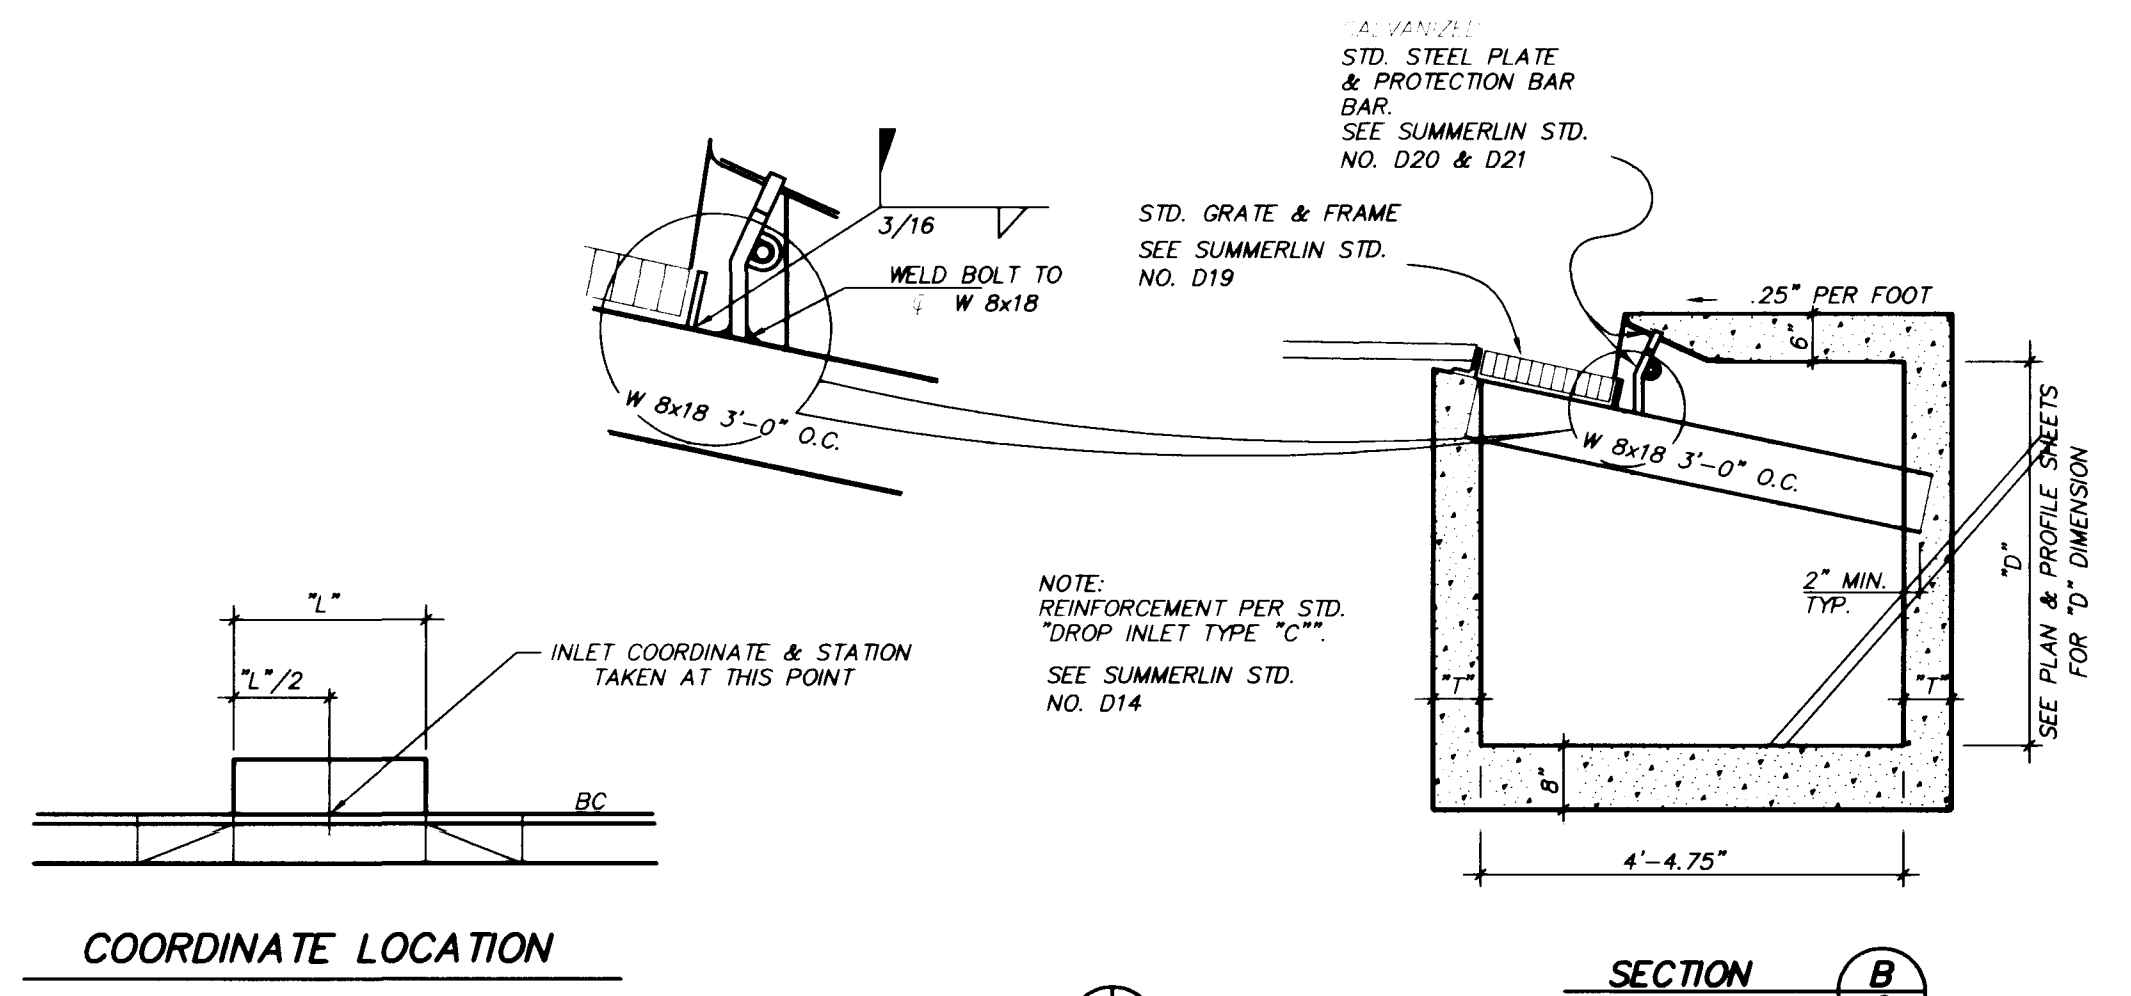
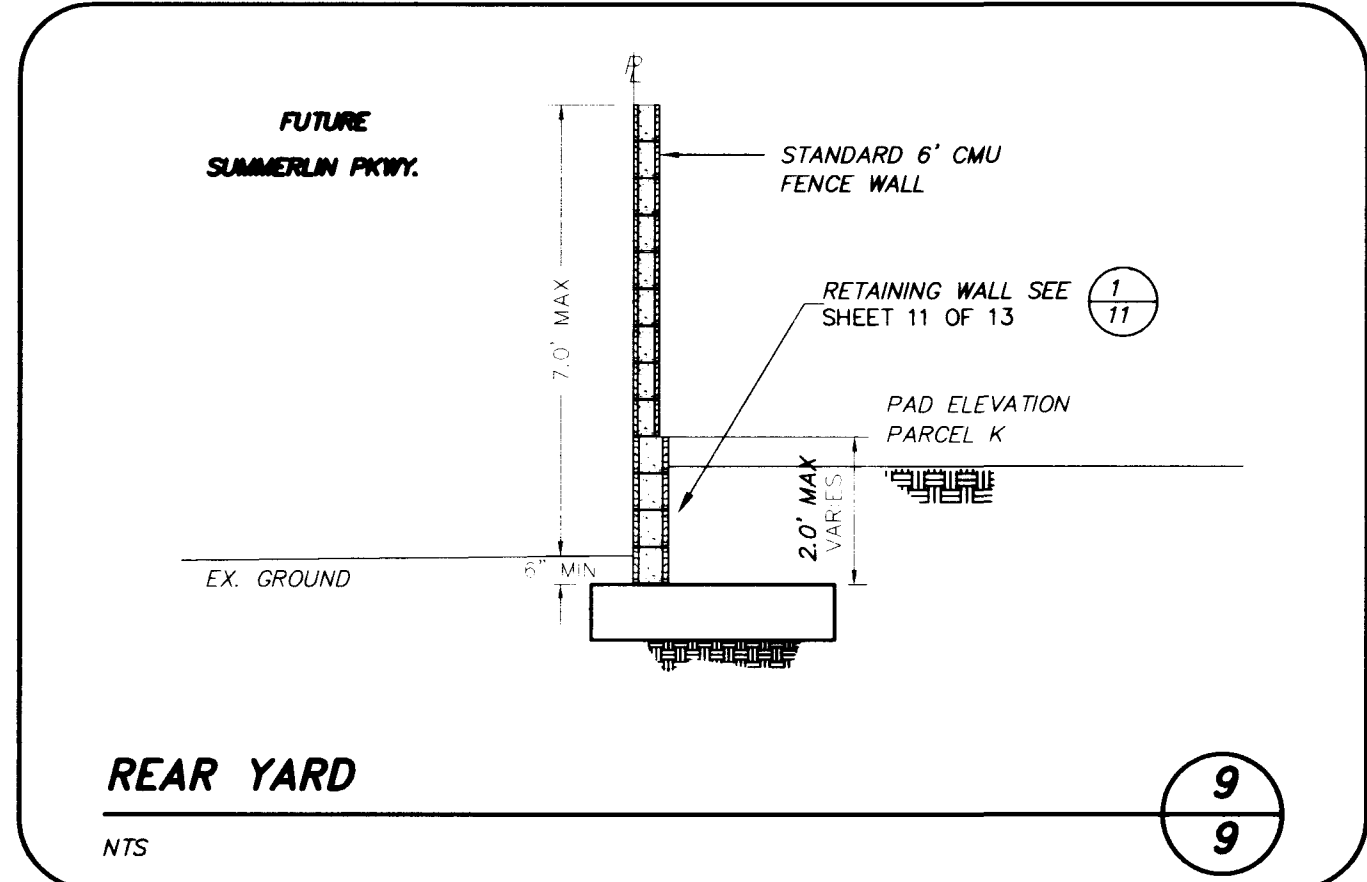
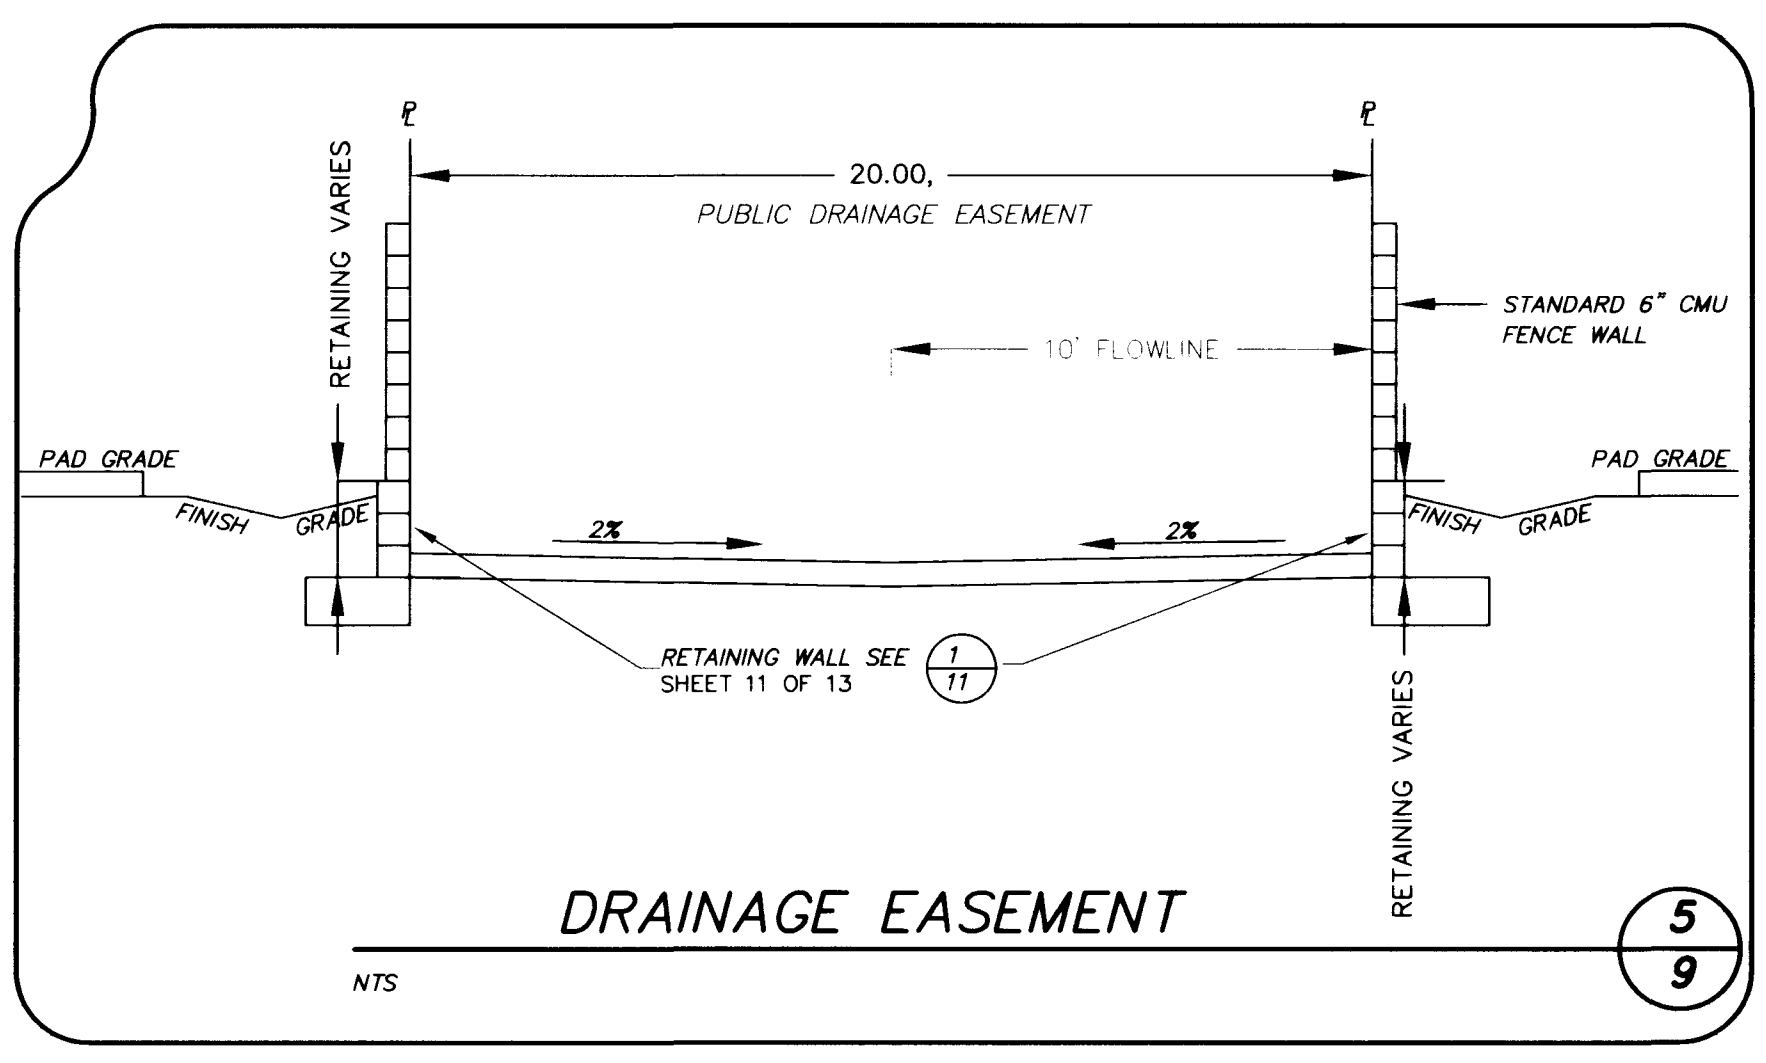
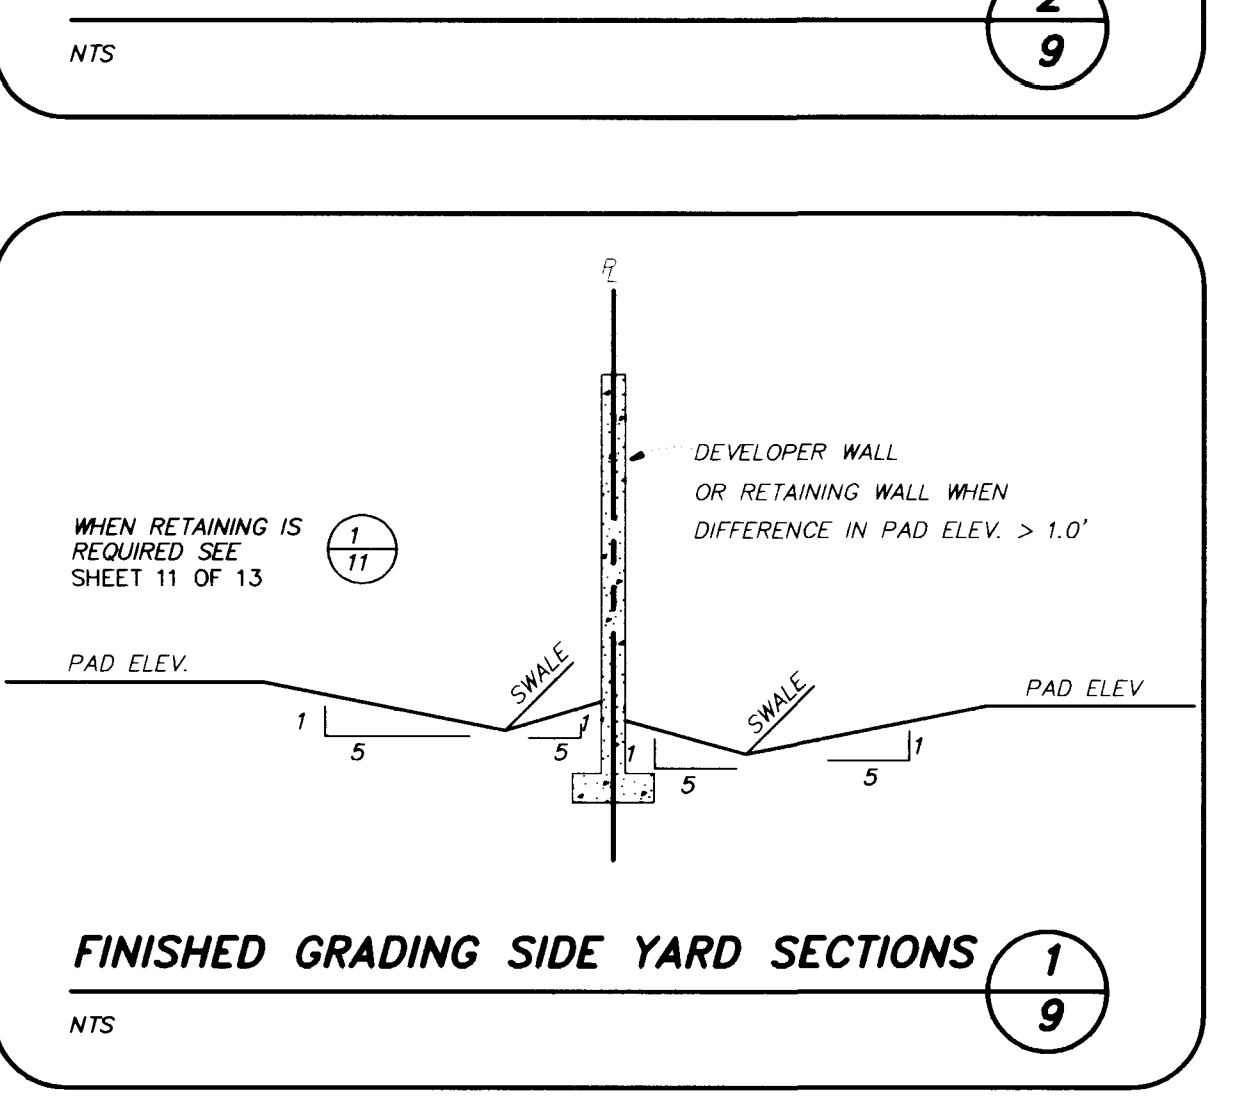
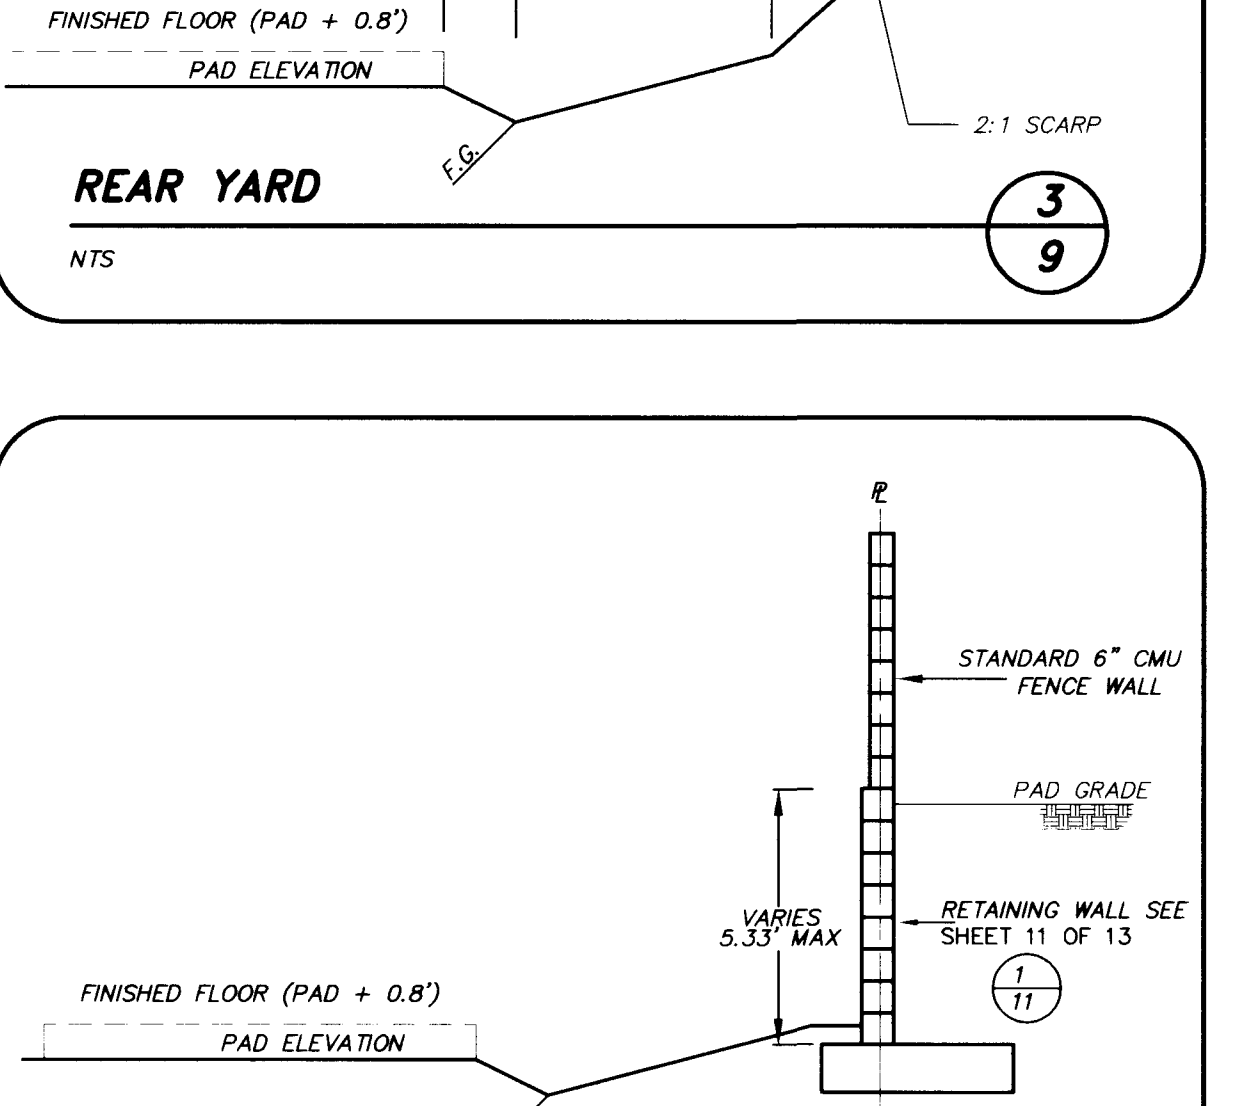
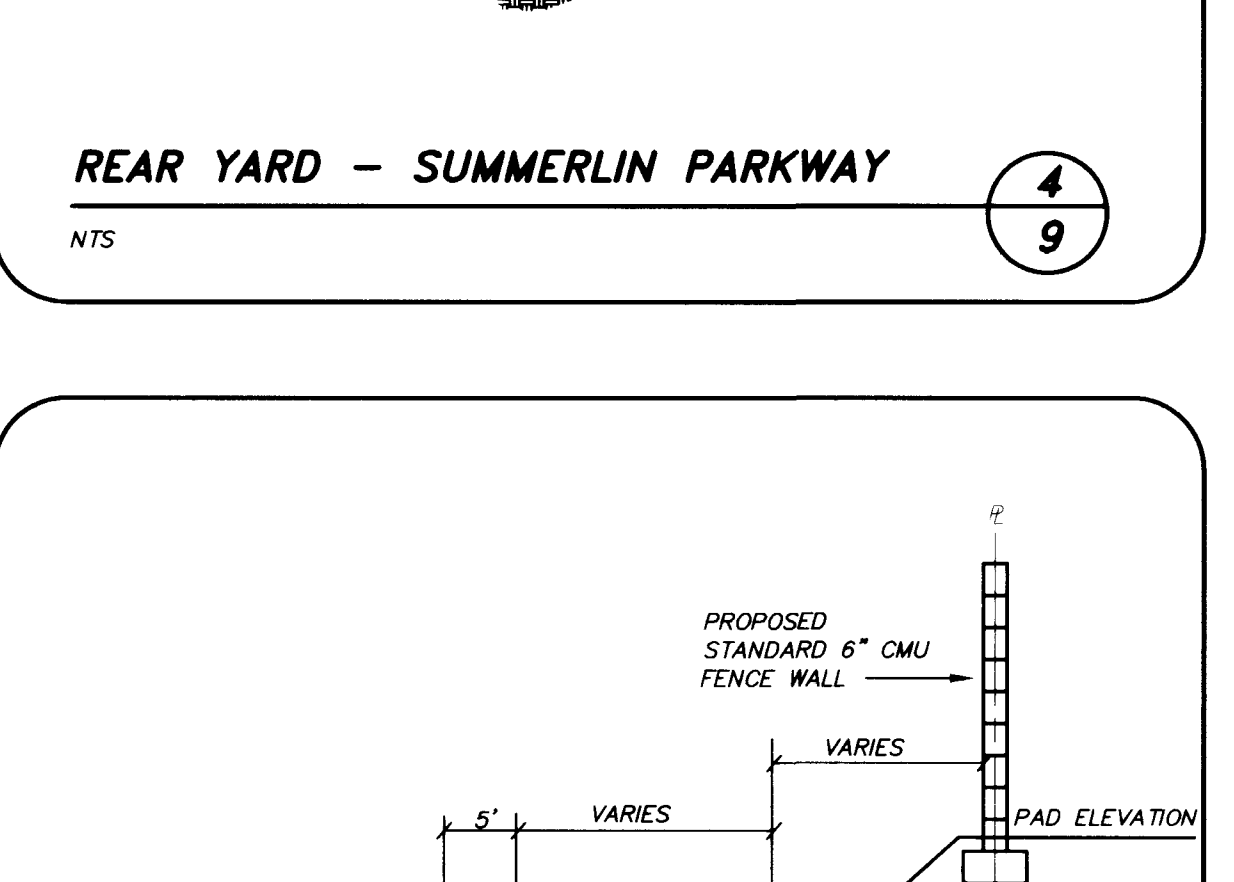
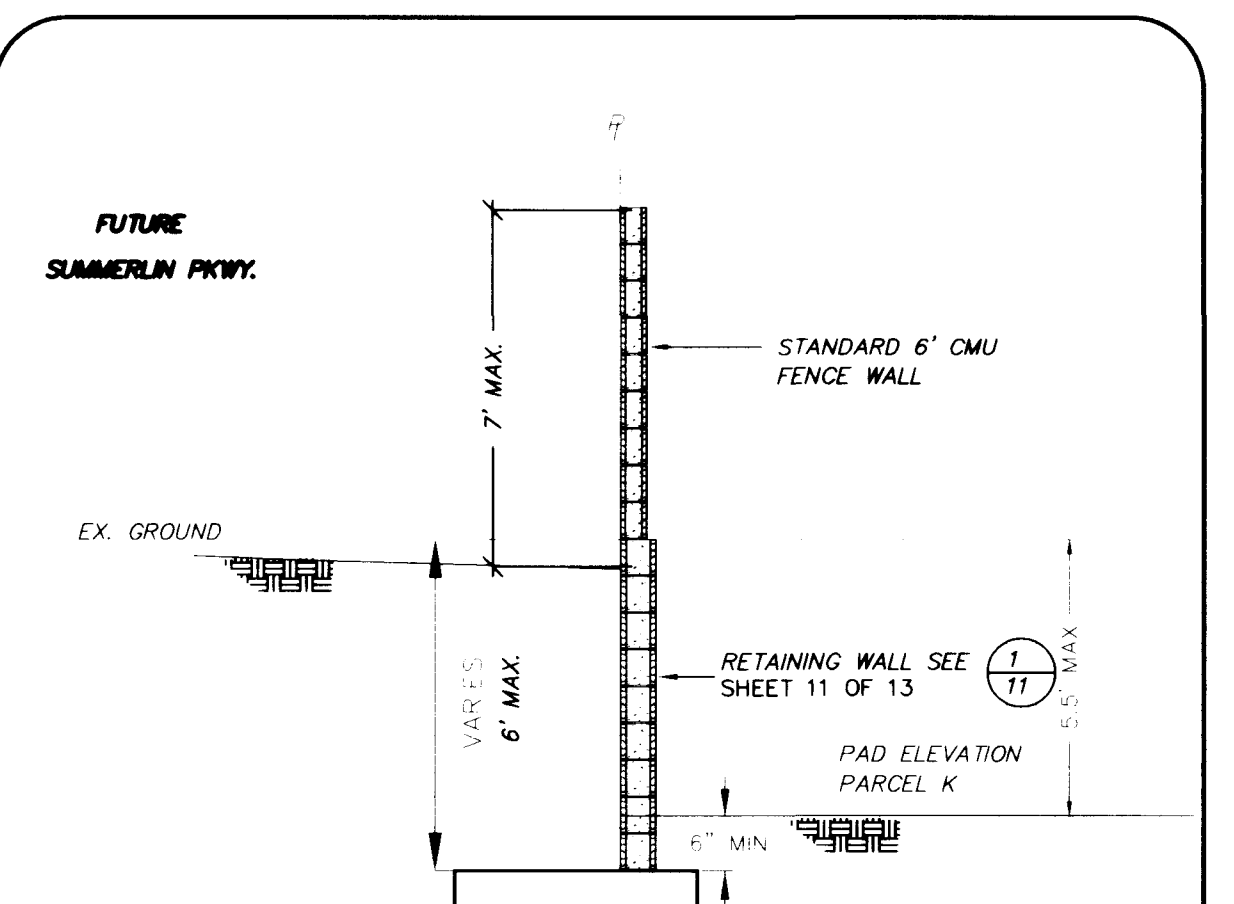
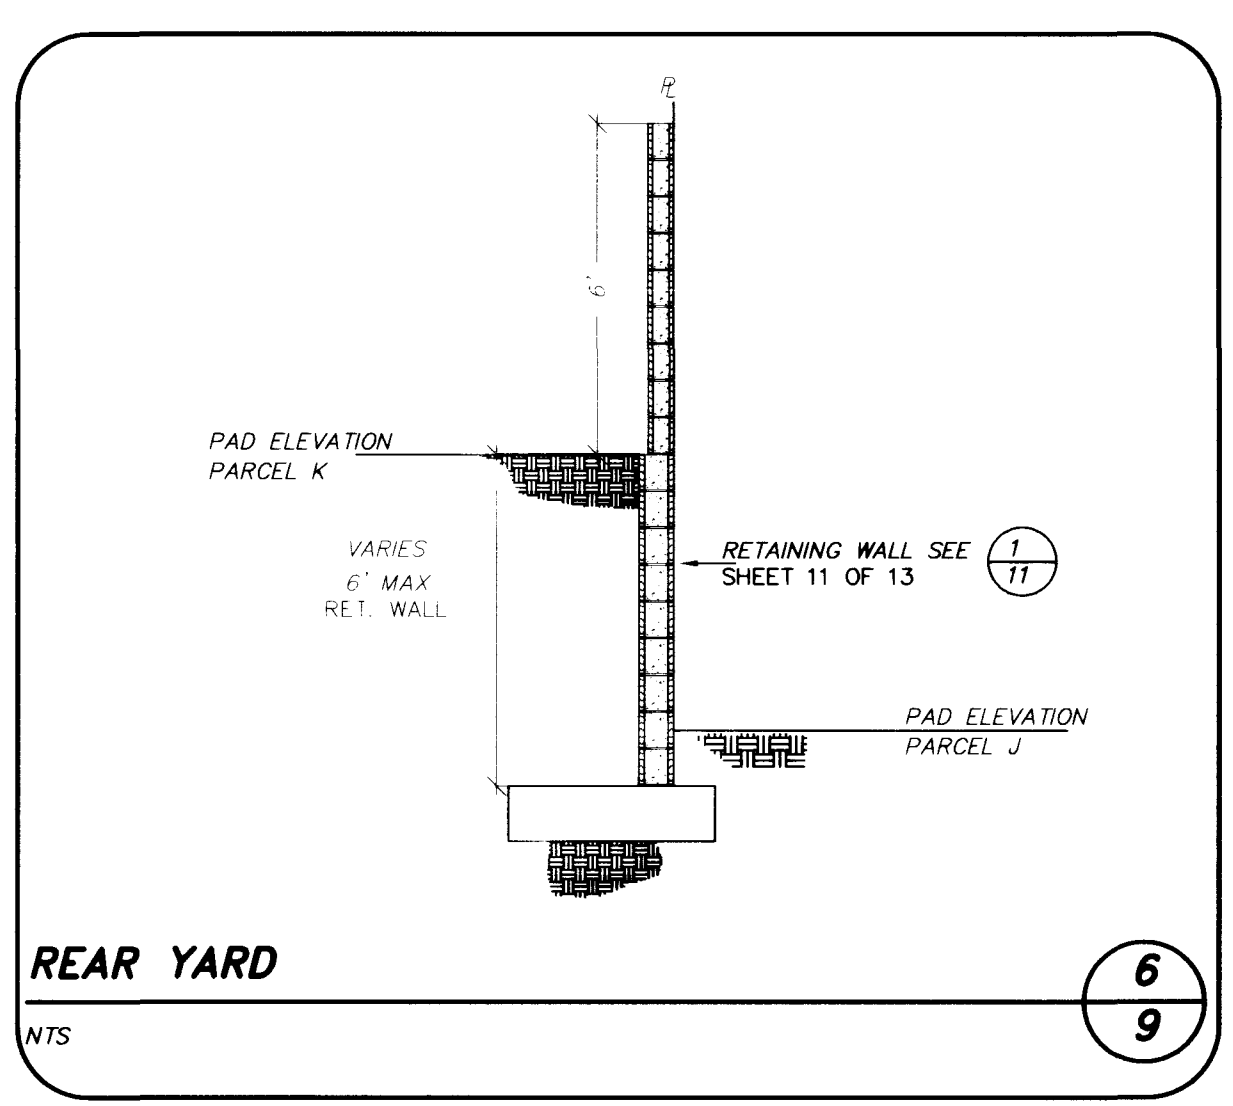


T TABLE	
"D"	"T"
2'-0" TO 8'-0"	6"
8'-1" TO 20'-0"	8"

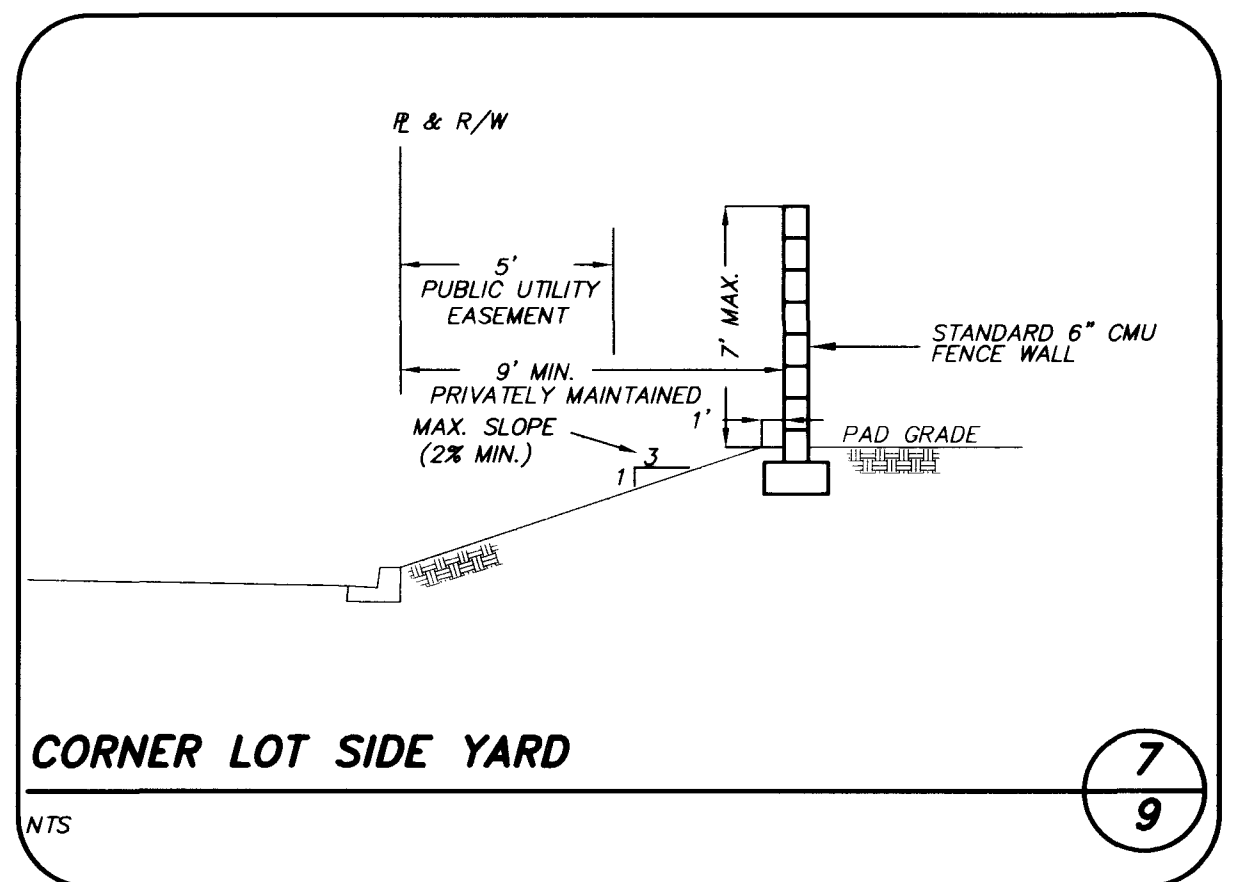

TYPICAL DETAIL FOR MODIFIED TYPE "C" DROP INLET FOR INLET LENGTH = 2.5 FEET TO 23.5 FEET
SCALE: 1/2" = 1'-0"

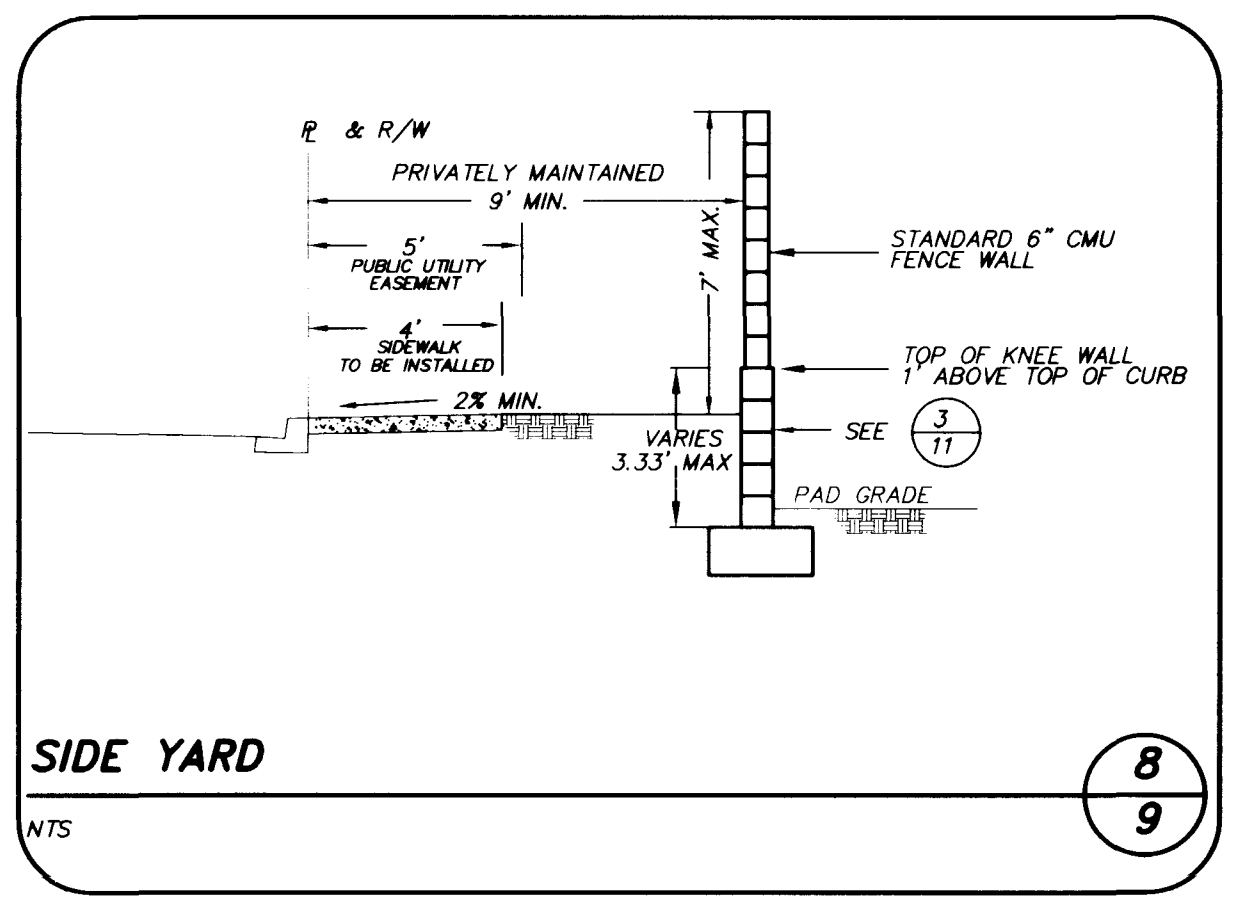

COLEMAN HOMES

G. C. WALLACE, INC.
Engineering/Architecture
1555 SOUTH RAINBOW BLVD., LAS VEGAS, NEVADA 89102
(702) 363-1200

GRADING PLAN DETAILS I

OAK HILLS AT SUMMERLIN - PHASE III

SHEET: 05/15/99
DESIGNED BY: GCW
CHECKED BY: GSN
PROJECT NO: 743.162

SCALE: N/A
HOR: N/A
VERT: N/A

SEAL
THOMAS R. DYSON
REGISTERED PROFESSIONAL ENGINEER - STATE OF NEVADA
No. 11306
1-13-99

SHEET **G-4**
9 OF 13 SHEETS
DRAWING NO. **107Y-4506-3**

GCW PROJ # 743.162

14143

