

PLAN NOTES

P	DESCRIPTION
P1.	DASHED LINE INDICATES STRUCTURE ABOVE TELEPHONE
P2.	NEW CONCRETE STAIR AND WALL TO MATCH EXISTING
P3.	ALIGN WALL BETWEEN WINDOWS
P4.	AUDITORIUM WALLS SHALL BE WITH 2" THICK FABRIC ACOUSTICAL WALL PANELS SEE INTERIOR ELEVATIONS
P5.	CLERESTORY AUDITORIUM AND PLATFORM WINDOW SHALL HAVE MOTORIZED BLACKOUT SHADES
P6.	NEW ACCESSIBLE RAMP AND RAILING
P7.	FIRE EXTINGUISHER CABINET. SEE 14/A9.01
P8.	NEW STAIR AND HANDRAIL
P9.	MECHANICAL/MOTORIZED LIFT TO PLATFORM
P10.	RELOCATED ELECTRICAL PANEL SYSTEM. SEE ELECTRICAL DRAWINGS
P11.	NEW CASEWORK
P12.	NEW TWO-BAY SINK. SEE PLUMBING DWGS.
P13.	NEW REFRIGERATOR - N.I.C.
P14.	NEW CMU WALL ENCLOSURE. SEE 5/AS2.01
P15.	STEEL BOLLARD. SEE DETAIL SHEET AS2.01
P16.	CONCRETE PIER. SEE STRUCTURAL DWGS.
P17.	GATE ENCLOSURE-SEE DETAIL 6/AS2.01
P18.	LINE OF EXISTING SKYLIGHT TO BE RESTORED.
P19.	REMOVEABLE RAILING FOR TRUCK DELIVERY. SEE DETAIL 1/A1.33.
P20.	PROVIDE HORIZONTAL MANUAL WINDOW BLIND AT THIS WINDOW
P21.	EXISTING CONCRETE COLUMN TO REMAIN
P22.	DRINKING FOUNTAIN. SEE PLUMBING DWGS.
P23.	EXISTING FOUNTAIN TO BE RENOVATED
P24.	EXISTING COVERED BREEZEWAY
P25.	EXISTING CONSTRUCTION TO BE REMOVED AND/OR RESTORED WITH DOORS AND/OR WINDOWS TO MATCH HISTORIC ERA- REFER TO WINDOW AND DOOR SCHEDULE
P26.	FURNITURE SHOWN ON PLAN SHALL BE TENANT FURNISHED AND TENANT INSTALLED
P27.	NEW SINK. SEE PLUMBING DWGS.
P28.	EXISTING BASEMENT STAIR TO REMAIN
P29.	INFILL STAIRWELL & CAP WITH CONC. SLAB
P30.	EXISTING CONCRETE WALL TO BE REMOVED
P31.	SAND AND FINISH EXISTING CONCRETE WALL FOR PAINT
P32.	NEW BABY CHANGING STATION
P33.	ALIGN FACE OF NEW PARTITION WITH FACE OF EXISTING CONCRETE
P34.	NEW COUNTER TRASH DISPOSAL
P35.	ACCESS LADDER AND HATCH SEE 5/A7.31
P36.	NEW CONCRETE. SEE 11/AS2.01
P37.	1" RECESS INFILL PER 4/A9.05
P38.	LINES INDICATE DIRECTION OF WOOD PLANK FLOORING. SEE STRUCTURAL DWGS.
P39.	RECONSTRUCT SEGMENT OF PARTIAL HEIGHT WALL TO MATCH ADJACENT EXISTING WALL
P40.	REMOVE DOOR, INFILL OPENING WITH CONCRETE, FLUSH TO EXTERIOR WALL
P41.	MATCH EXISTING FINISH AND TEXTURE
P42.	PATTERNED GLASS WINDOW PER SPEC.
P43.	EXISTING METAL GATE
P44.	ROOF DRAIN SEE DETAIL 3/A7.31
P45.	INSTALL NEW CABINET DOORS ON EXISTING CABINET. SEE DETAIL 5/A8.02
P46.	STAGELAM HIGH TRAFFIC FLOORING
P47.	EXISTING CONCRETE PAIL TO REMAIN
P48.	EXISTING DIVIDED LIGHT TRANSOM/DOOR ASSEMBLY
P49.	CONCRETE SUMP PIT W/ STEEL GRATE
P50.	FURR OVER WINDOW


GENERAL NOTES

- DIMENSIONS ARE TO FACE OF STUD. FACE OF MASONRY OR FACE OF CONCRETE UNLESS NOTED OTHERWISE.
- INFORM ARCHITECT OF ANY DISCREPANCIES BEFORE BEGINNING WORK.
- PRIOR TO CONSTRUCTION, CONTRACTOR SHALL FIELD VERIFY ALL EXISTING CONDITIONS. IN AREAS REQUIRING REPAIR AND/OR REMOVAL, CONTRACTOR SHALL PATCH AND PREP SURFACES FOR NEW FINISH.
- PATCH ALL HOLES IN EXTERIOR CONCRETE WALLS INCLUDING LADDER HOLES, CONDUIT, AND PIPE HOLES, ETC. CAUSED BY DEMO. REPAIR AND PAINT ALL CRAWL SPACE VENT GRILLES - TYPICAL.



WALL TYPES

- NOTES**
- WALL TYPES WITH AN 'S' SUBSCRIPT INDICATE FIBERGLASS ACOUSTICAL INSULATION FULL HEIGHT AND DEPTH OF PARTITION NOTED AND REQUIRES THE GYP. BOARD TO EXTEND FROM TOP OF FLOOR SLAB TO UNDERSIDE OF STRUCTURE ABOVE ON ONE SIDE OF PARTITION THAT OTHERWISE WOULD NOT EXTEND TO THE STRUCTURE ABOVE.
 - PROVIDE HEAVY GAGE METAL STUDS IN LIEU OF LIGHT GAGE METAL STUDS AT WALLS WITH ANY WALL HUNG TYPE ATTACHMENTS AND/OR SUPPORTING ATTACHMENTS SUCH AS WALL SINKS, GRAB BARS, WALL CABINETS AND OTHER MISC. EQUIPMENT.
 - ALL WALLS IN WET AREAS SHALL HAVE 5/8" TYPE 'X' WATER-RESISTANT GYPSUM BOARD IN LIEU OF 5/8" TYPE 'X' (REGULAR) GYPSUM BOARD.
 - ALL INTERIOR PARTITIONS ARE NON-BEARING.
 - WALLS WITH SUBSCRIPT 'T' INDICATES WALLS WITH THERMAL INSULATION FOR THE FULL HEIGHT OF THE WALL.

WALL LEGEND

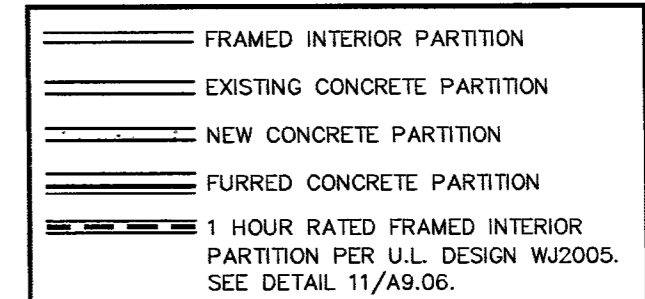

BUILDING MAP

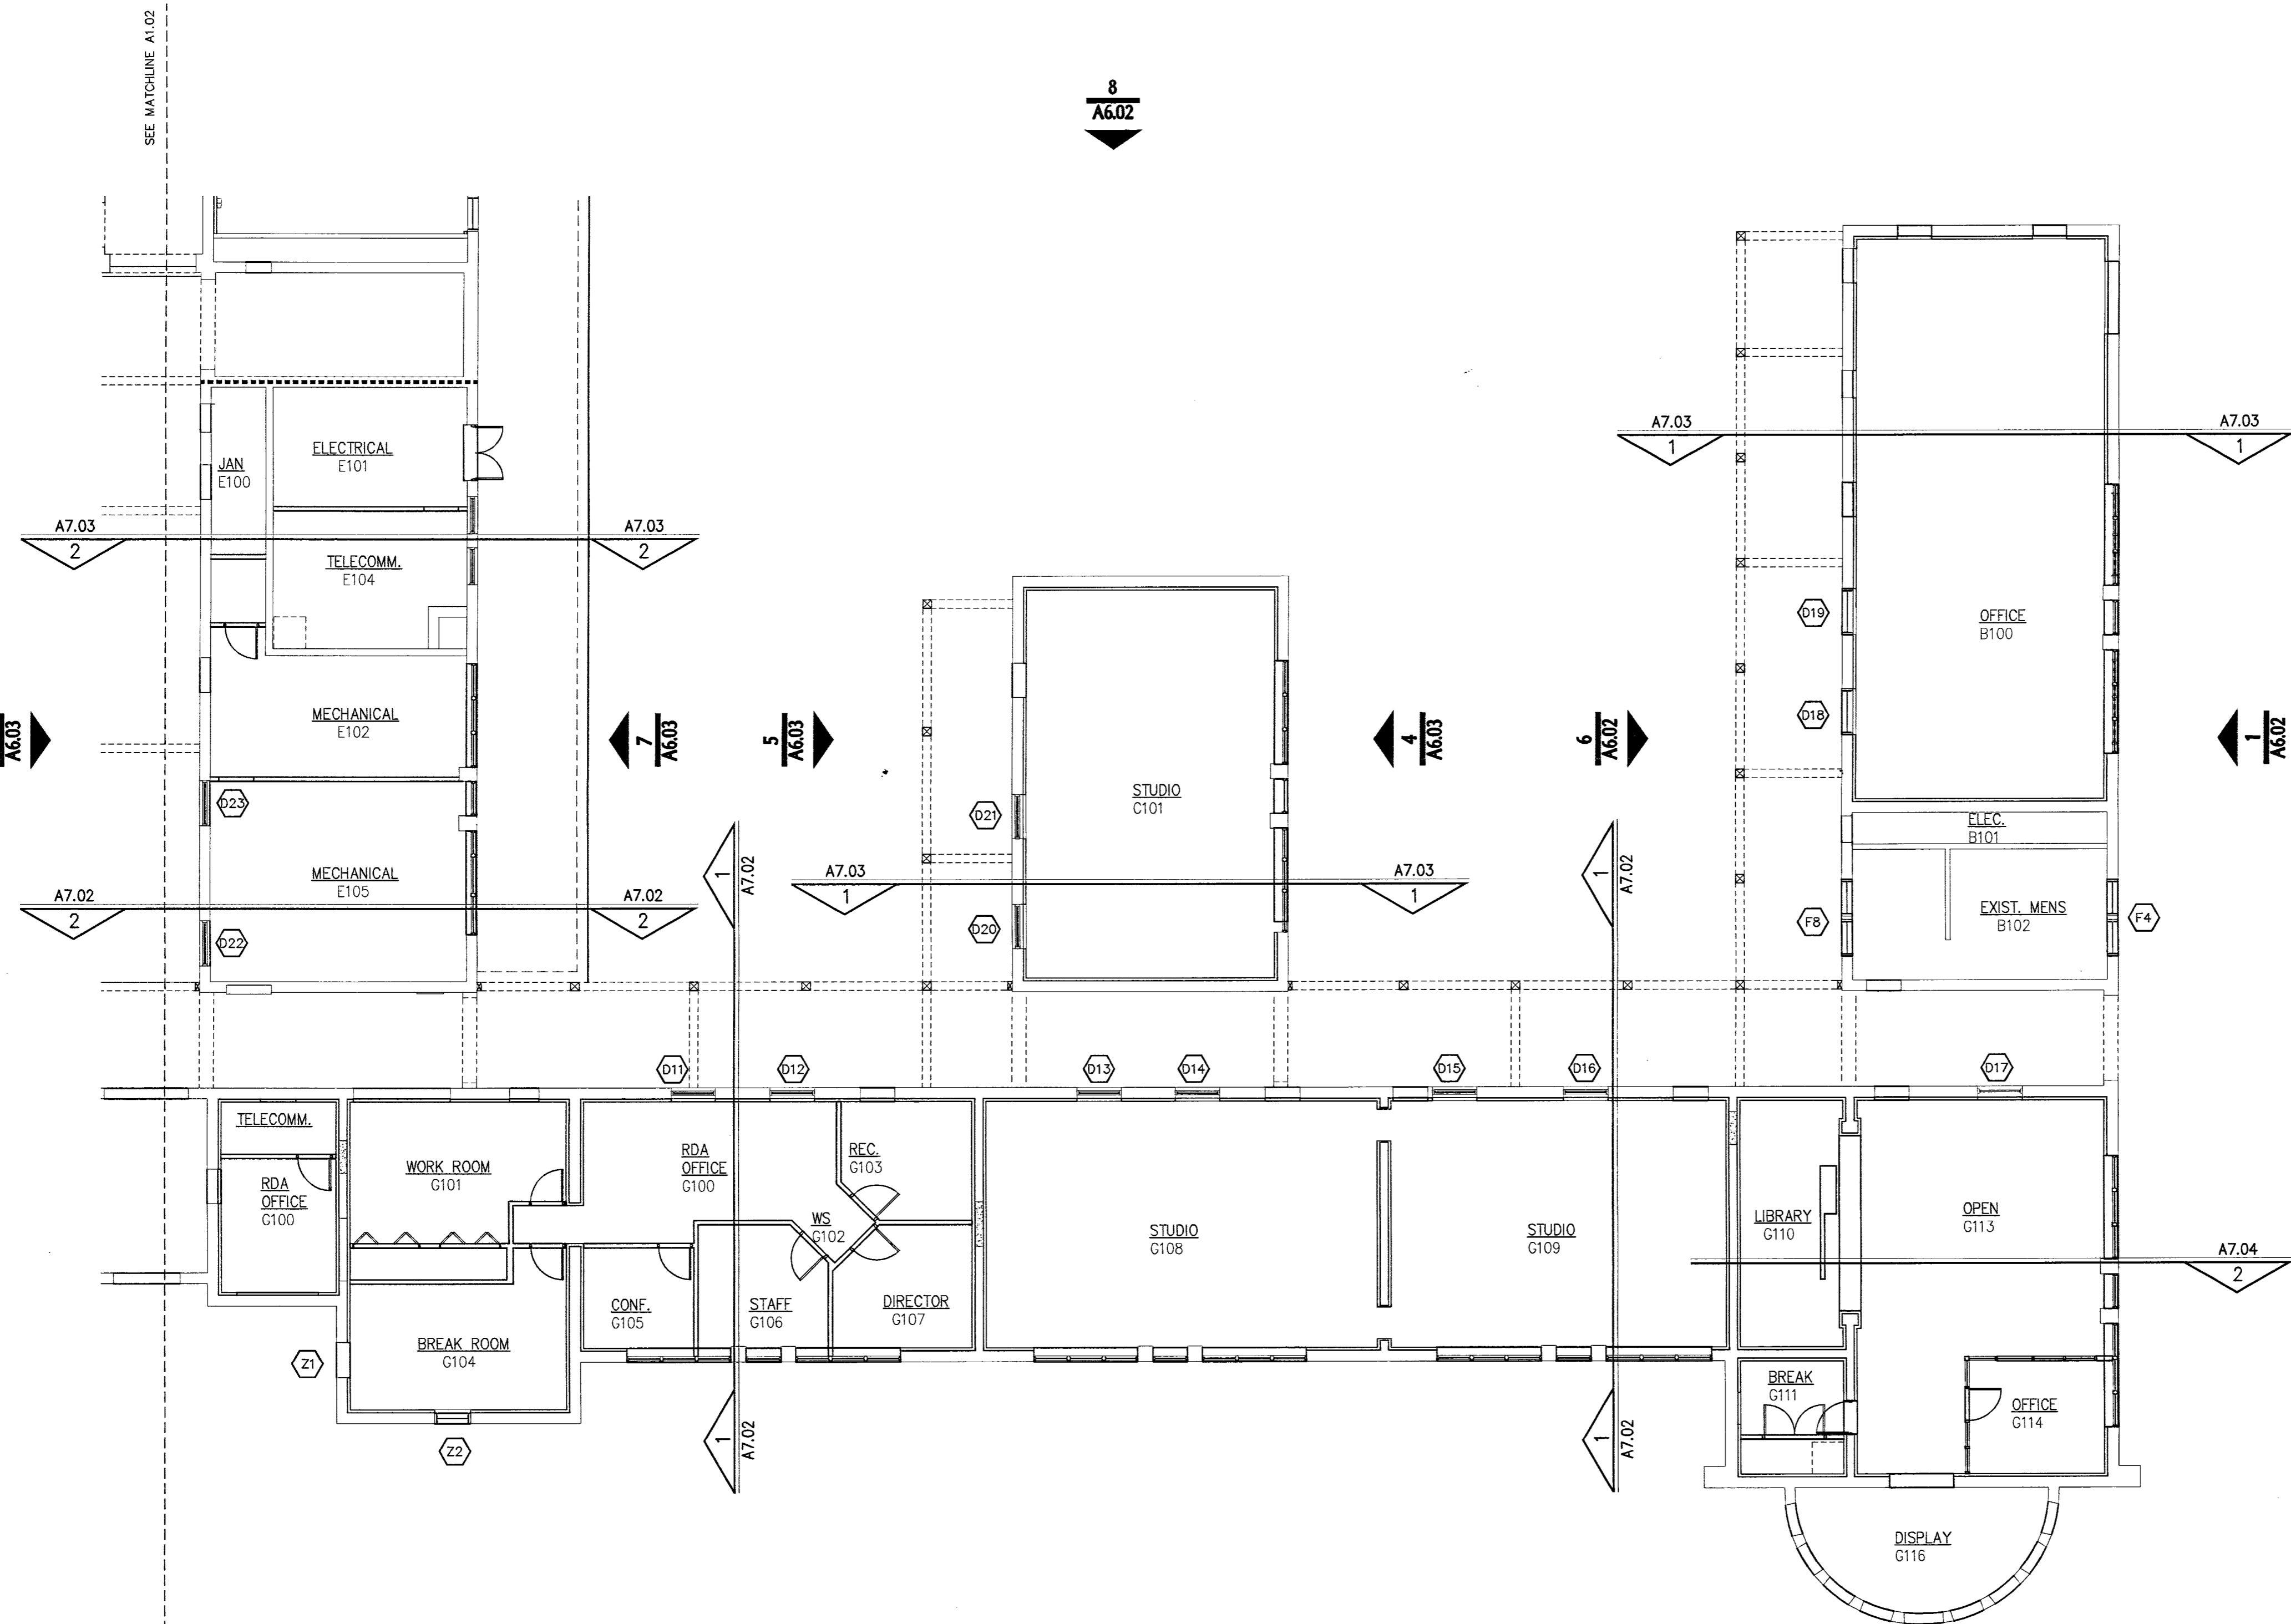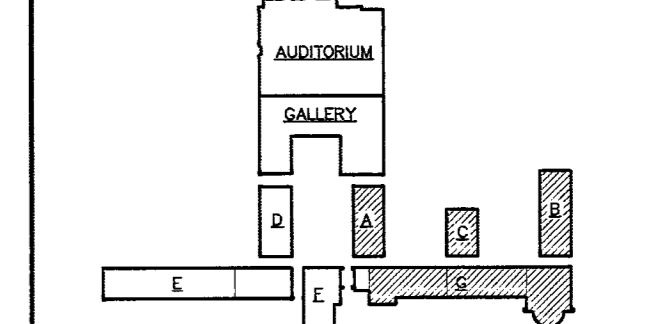

8
A6.02

8
A6.03

PLANS APPROVED
ARCHITECTURAL
City of Las Vegas, Nevada
JCF JAN 12 2007
Does Not Include Electrical, Plumbing, Mechanical, Structural or CE-Title Improvements Made No Charge Without Approval Permit to Not a Permit to Violate Any Ordinance

CONSULTANT
KGA ARCHITECTURE
440 EAST STEWART AVENUE
LAS VEGAS, NEVADA 89103
PHONE: (702) 229-8535
FAX: (702) 386-8846
TDD: (702) 386-9108

CONSULTANT
HERITAGE ARCHITECTURE & PLANNING
PHONE: 88-279-7888

CONSULTANT
YTH NEVADA
PHONE: 702-479-7200

CONSULTANT
BARKER DROTTER ASSOCIATES STRUCTURAL ENGINEERS
PHONE: 702-787-8500

CONSULTANT
MECHANICAL - PLUMBING - ELECTRICAL - LIFE SAFETY - ACOUSTICAL - GENERAL LIGHTING
SEA CONSULTING ENGINEERS
PHONE: 702-362-5200

CONSULTANT
STAGE LIGHTING & DESIGN - COMMERCIAL LIGHTING DESIGN GROUP
PHONE: 88-224-2223

CONSULTANT
LANDSCAPE - JMWZING & ASSOCIATES
PHONE: 702-787-8500

CONSULTANT
COST ESTIMATING - RIDER HUNT LEVETT & BAILEY
PHONE: 702-386-1988

CONSULTANT
ARCHITECTURE - ENDELMAN AND ASSOCIATES
PHONE: 202-337-9442

CITY OF LAS VEGAS
REDEVELOPMENT AGENCY
REVISION 12/2006

OWNER: CITY OF LAS VEGAS
DEPARTMENT OF PUBLIC WORKS
ARCHITECTURAL SERVICES

400 EAST STEWART AVENUE
LAS VEGAS, NEVADA 89103
PHONE: (702) 229-8535
FAX: (702) 386-8846
TDD: (702) 386-9108

DATE: 12/12/2006
SCALE: 1/8" = 1'-0"
DRAWING: 513-65E
SHEET NO: A1.03

PARTIAL MID-LEVEL PLAN
SCALE: 1/8" = 1'-0"