




FRONT ELEVATION

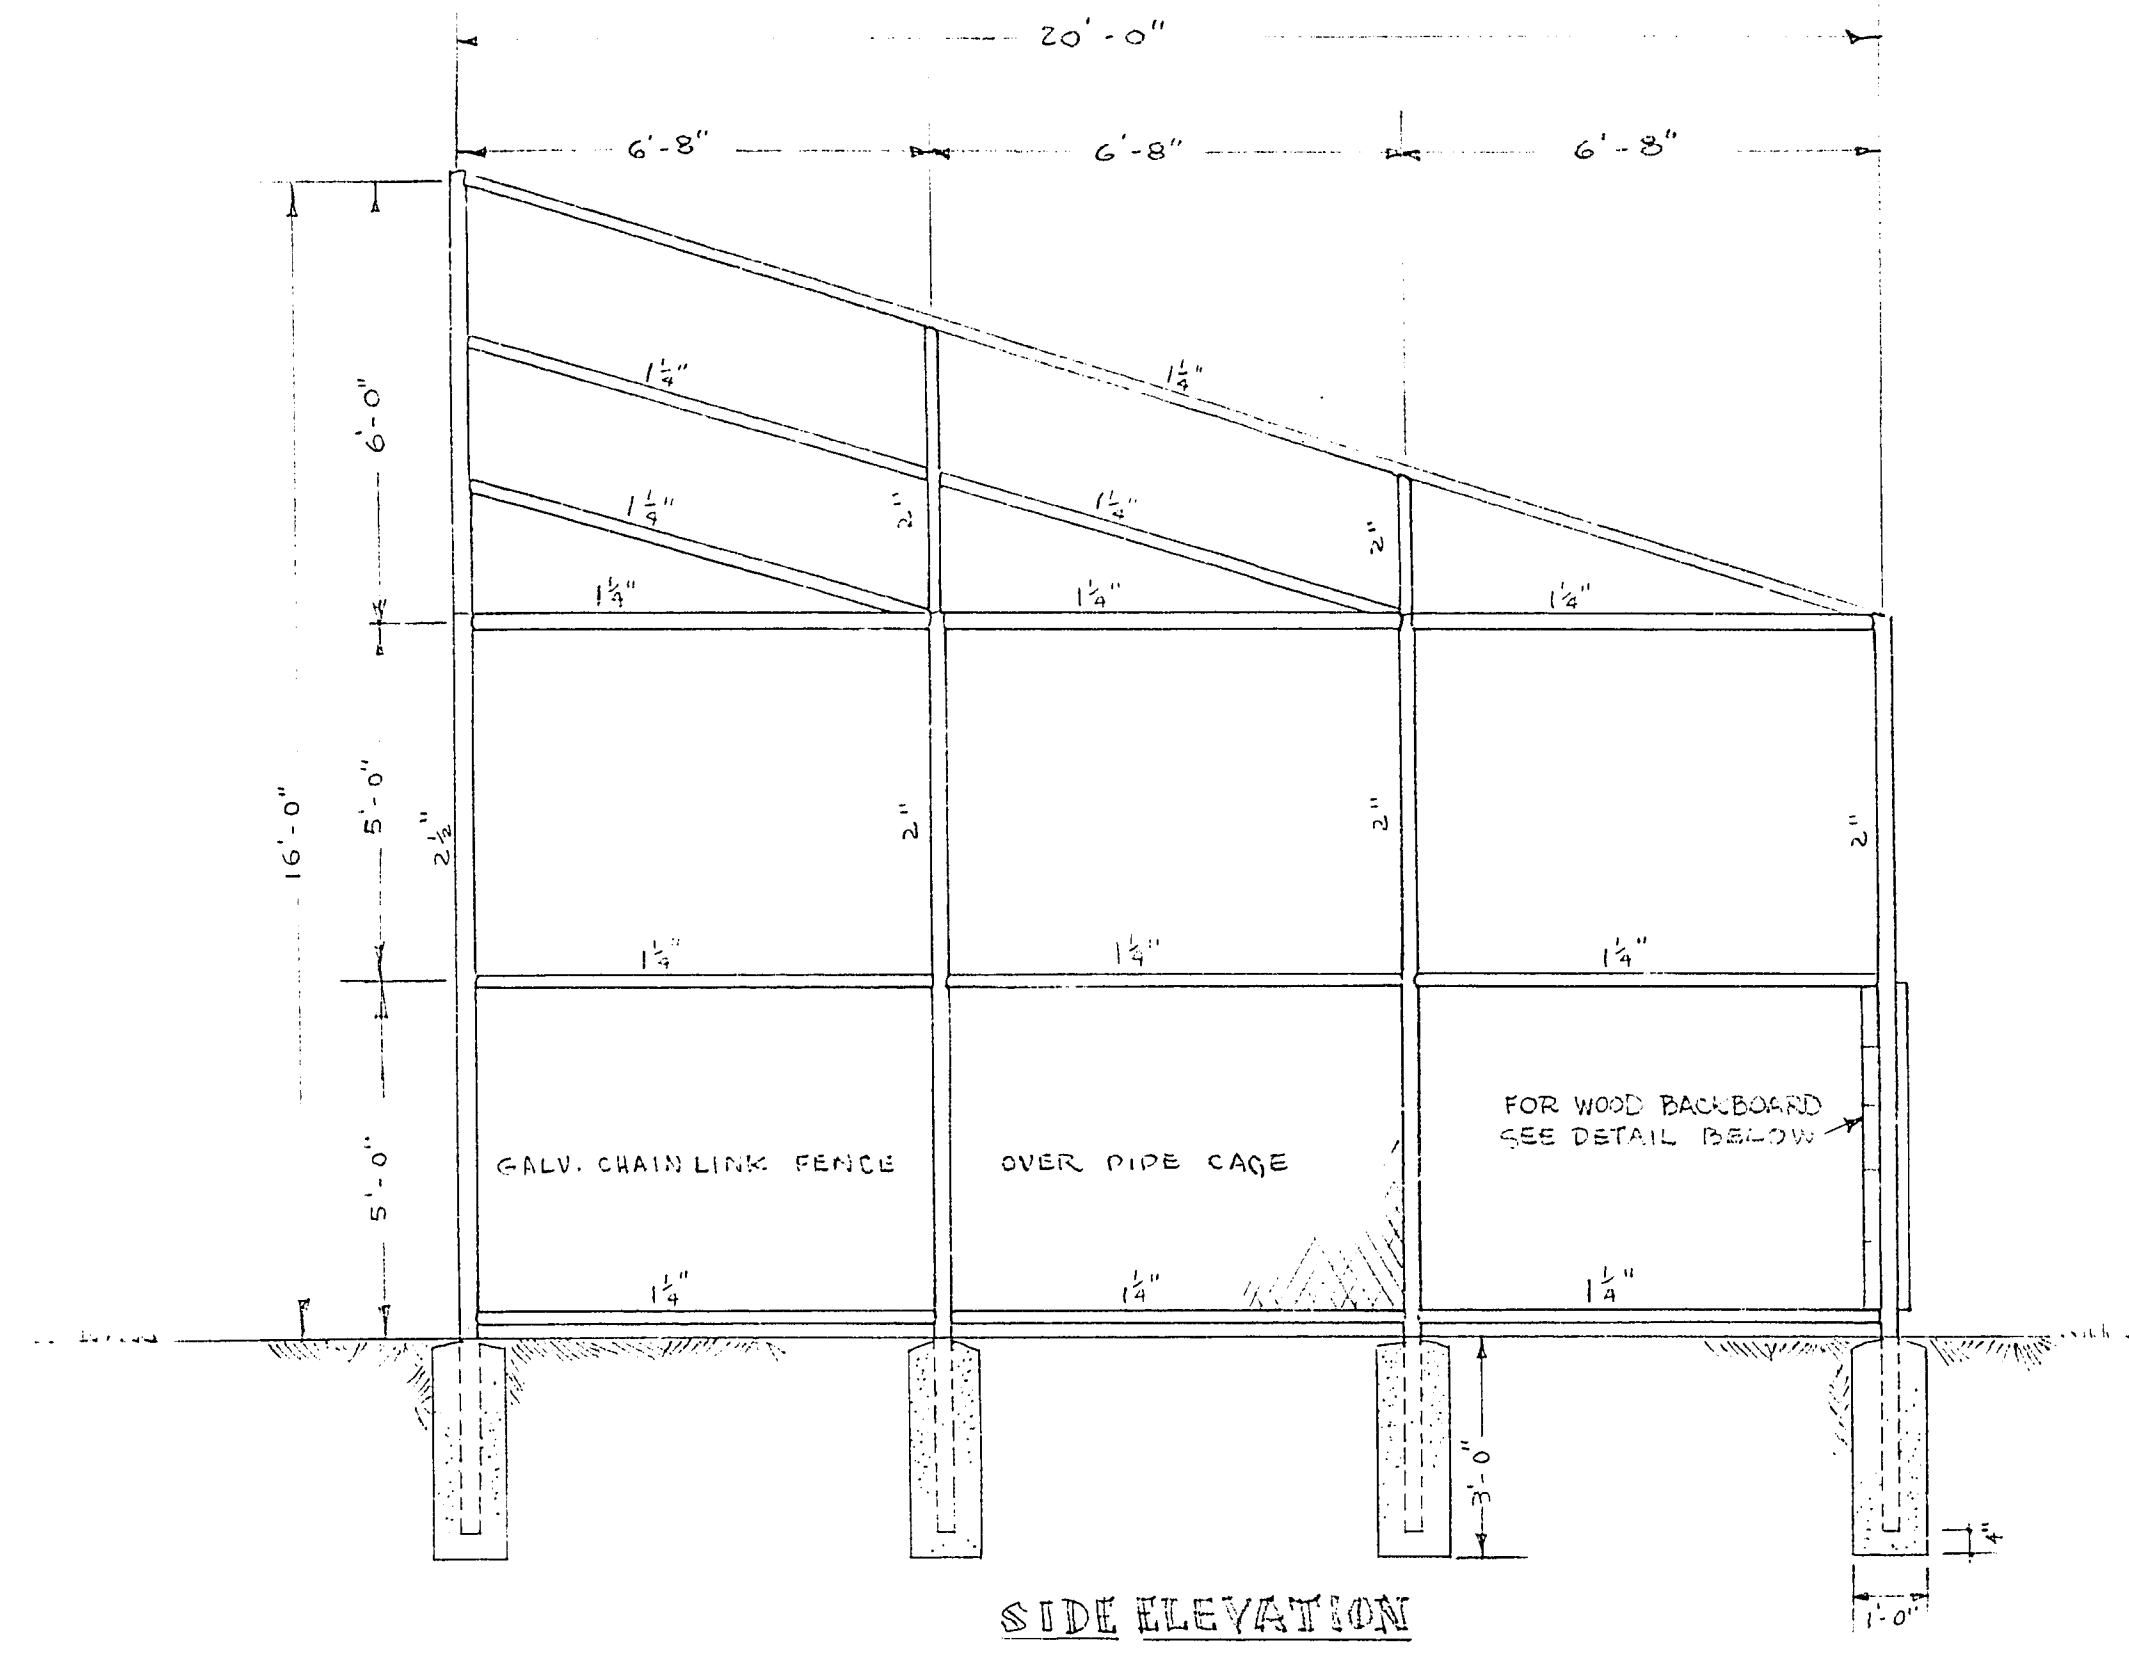

SIDE ELEVATION

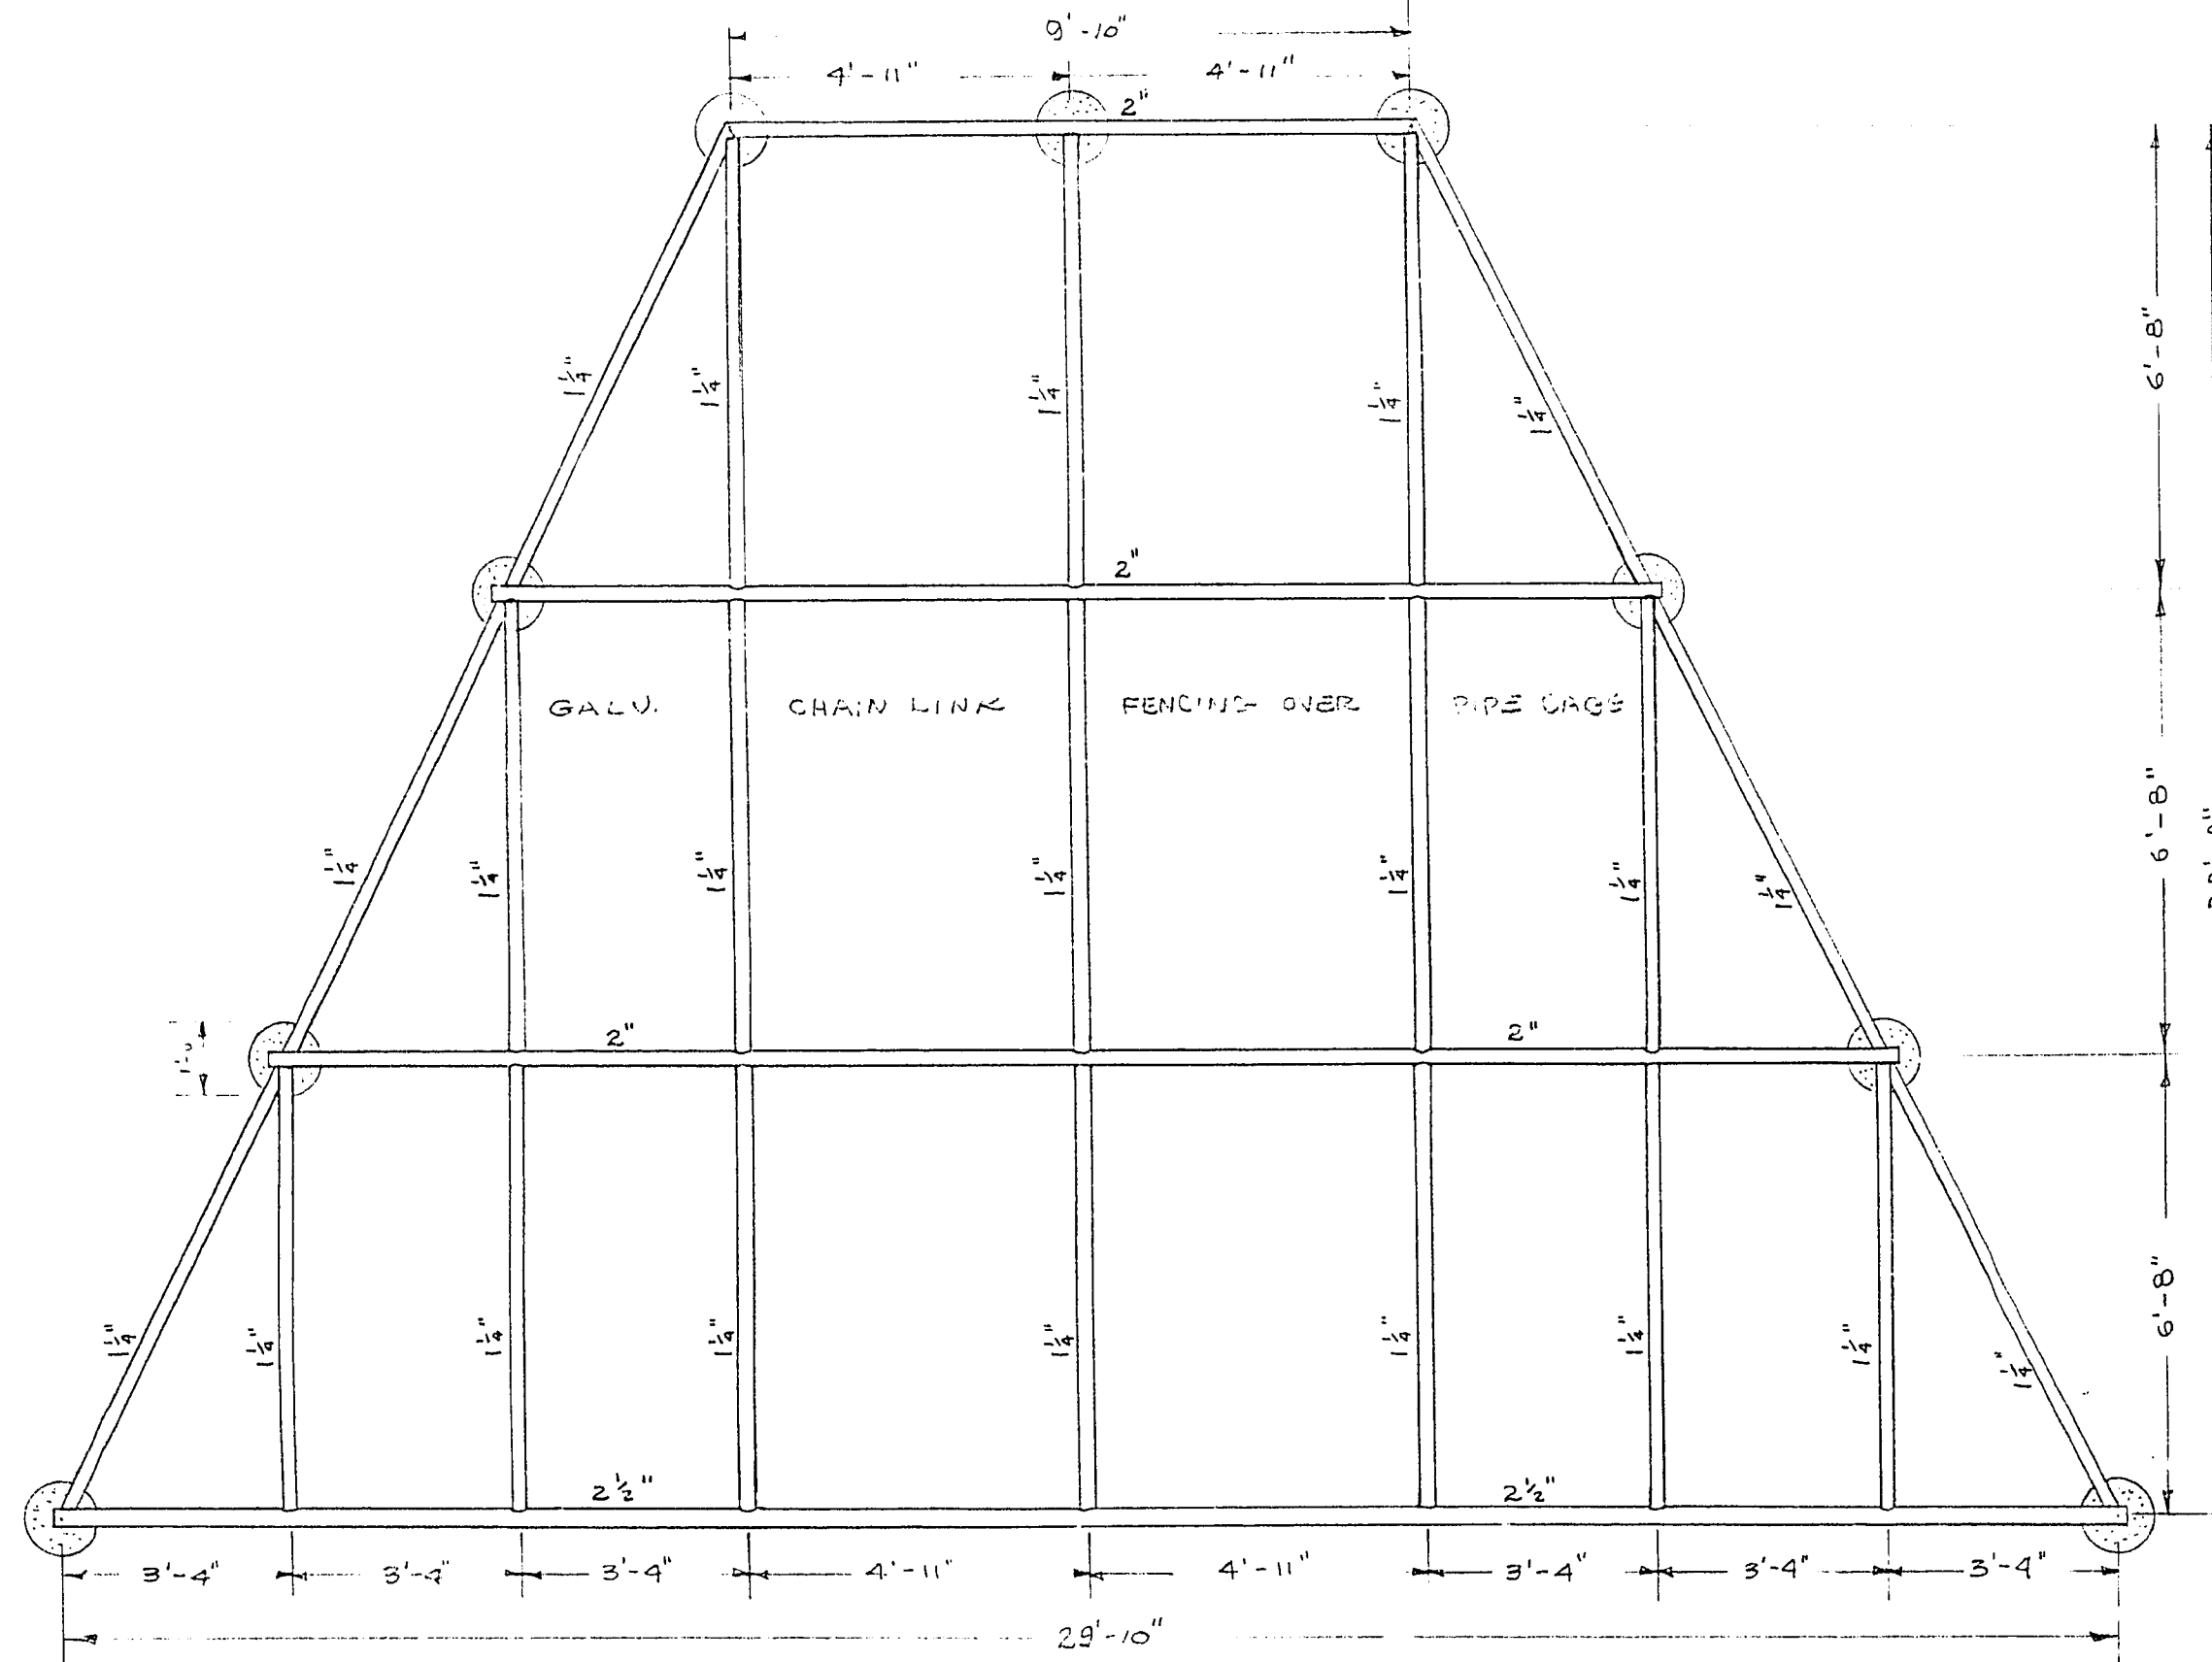

PLAN VIEW

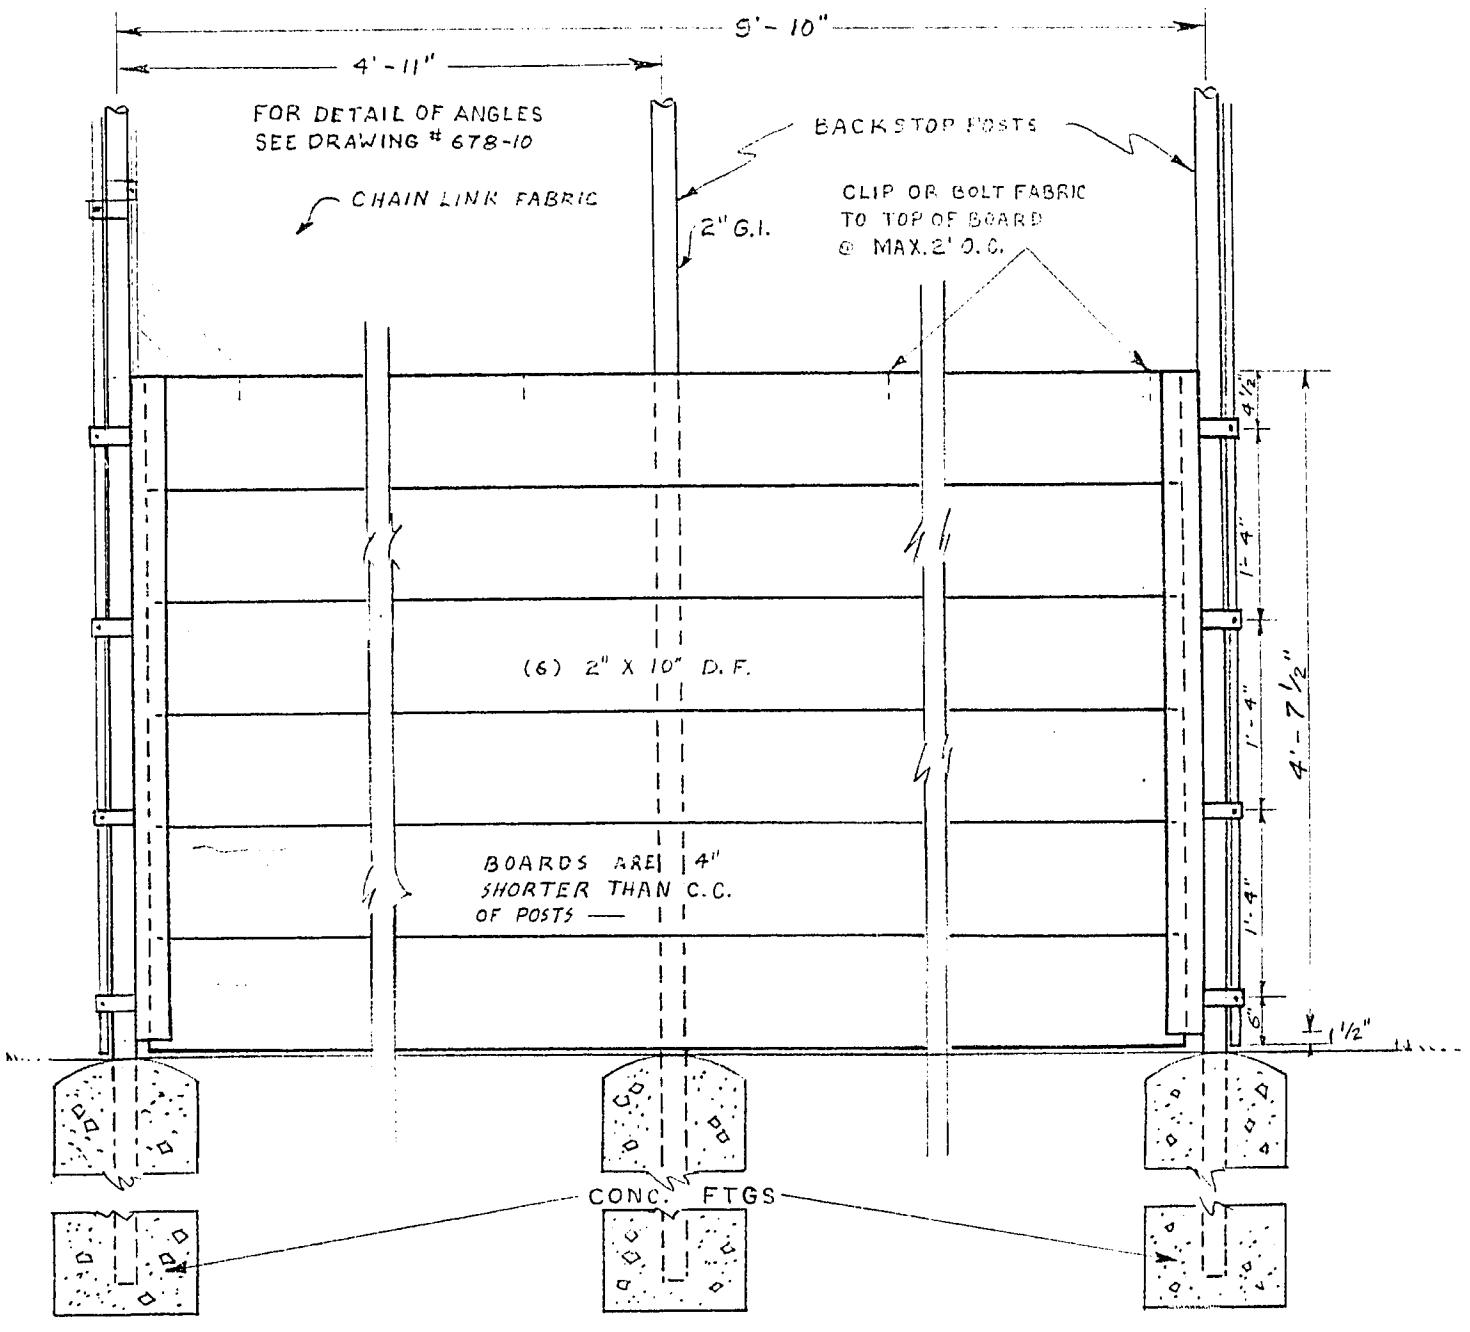

BACKBOARD DETAIL

SPECIFICATIONS:

- PIPES: ALL PIPES SHALL BE NEW STANDARD WT. GALV. STEEL PIPE, AND SIZE AS INDICATED.
- WELDING: ALL WELDS SHALL HAVE 3/16 BEADS. ALL WELDS SHALL BE CLEANED AND PAINTED ALUMINUM.
- FABRIC: FABRIC SHALL BE NO. 5 GAUGE COPPER BEARING STEEL WIRE, RIGHT HAND WEAVE, WOVEN INTO TWO (2) INCH (2") MESH AND HEAVILY GALV. AFTER WEAVING BY HOT DIP PROCESS. FABRIC TO BE TIED WITH NO. 10 GAUGE ROLL WIRE. FABRIC TO BE KNOCKLED.
- LUMBER: LUMBER SHALL BE STRUCTURAL GRADE DOUGLASS FIR STRESS GRADE 1600 E, S4S.
- CONCRETE: 2000# P.S.I.
- NOTE: PIPE CONNECTIONS SHOWN ARE WELDED, OTHER TYPES OF JOINTS WILL BE ACCEPTABLE PROVIDED THAT THE BACKSTOP ARRANGEMENT REMAINS SUBSTANTIALLY AS SHOWN AND A SHOP DRAWING IS SUBMITTED WITH THE SET.

APPROVAL

DATE
DEPARTMENT OF RECREATION

SEE DRAWING# 678-10 FOR ICRE DETAIL

**CITY OF LAS VEGAS NEVADA
ENGINEERING DEPT.**

POOLITTLE PARK
STANDARD BASEBALL BACKSTOP

DES.	DR. J. Mast	DATE	SC. (1) 3/8" = 1'-0"
CHKD.			SC. (1)
APPROVED BY CITY ENGR.			F. BK. NO.
			P.I. O. NO.
			DRAWING NO.
			678-12

Sheet 2 of 2

2513-14