

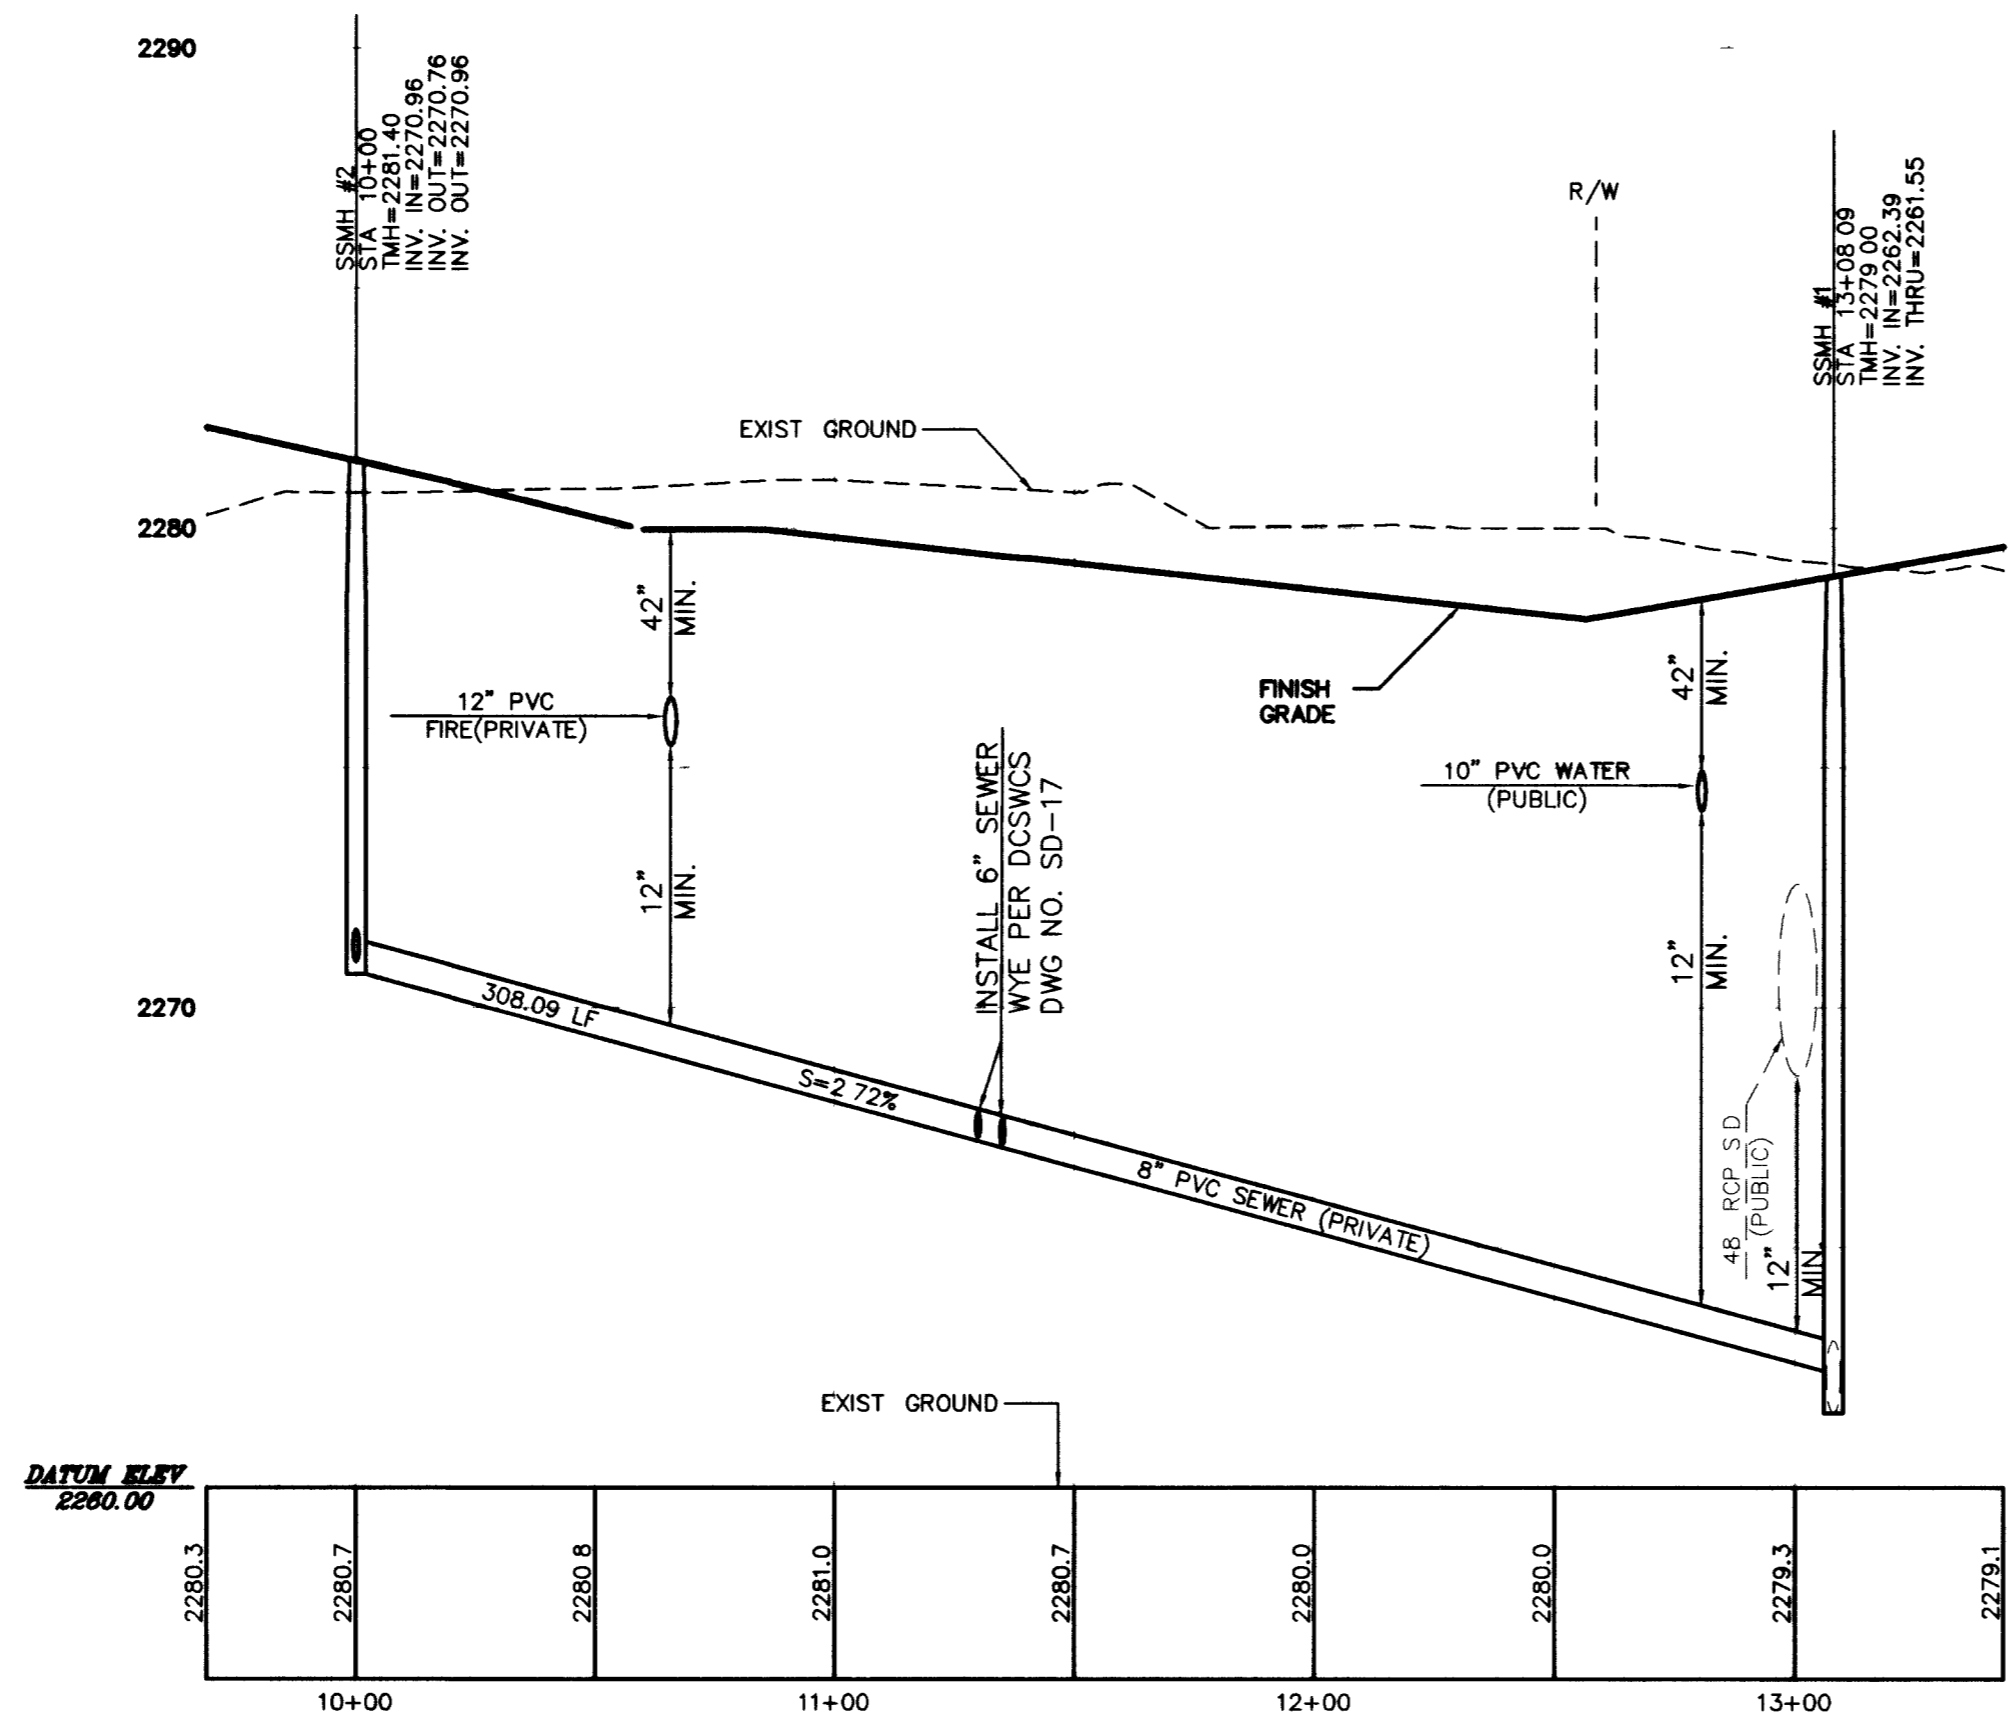
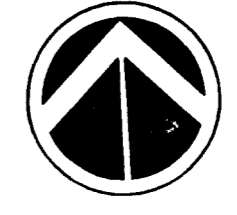



PLAN

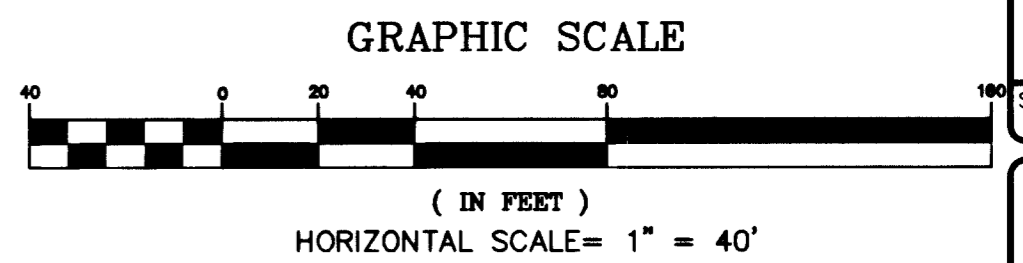

PROFILE  
**ONSITE SEWER SOUTH**  
 SEWER MANHOLE 2 TO SEWER MANHOLE 1  
 SCALE: HORIZONTAL = 1" = 40'  
 VERTICAL = 1" = 4'

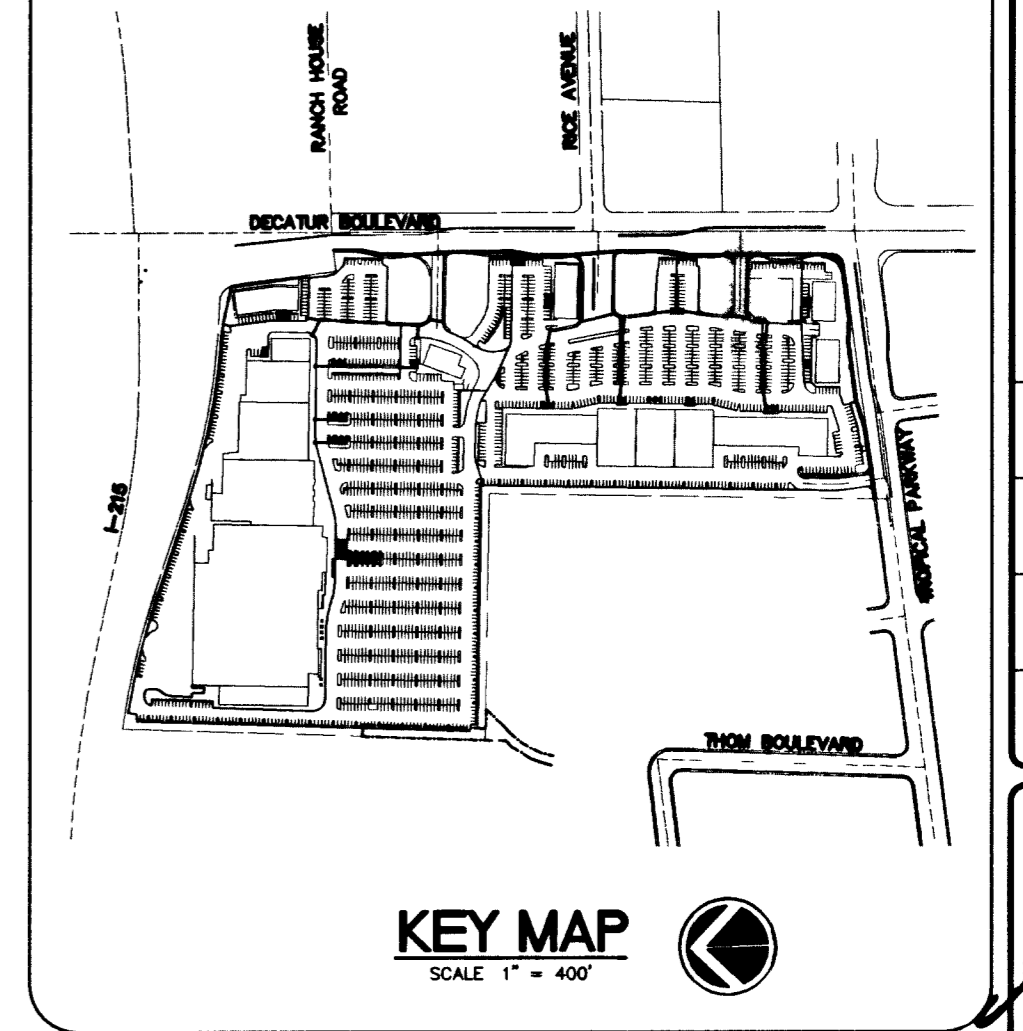

| NO. | DATE | BY | APP'D | REVISION DESCRIPTION |
|-----|------|----|-------|----------------------|
|     |      |    |       |                      |

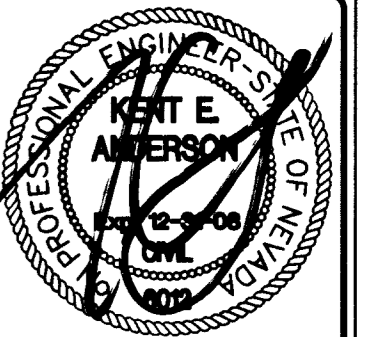

STAMP DATE: 4-15-08

3510 North Rancho Drive  
 Las Vegas, Nevada 89130  
 Telephone: (702) 648-2700  
 Fax: (702) 648-4143

**SOUTHWEST**  
 ENGINEERING  
 LANDSURVEYING • MAPPING • DEVELOPMENT

NEVADA

**ONSITE SEWER SOUTH PLAN AND PROFILE V**  
 SEWER MANHOLE 2 TO SEWER MANHOLE 1  
**DECATUR & TROPICAL**  
 DECATUR 215, LLC

TITLE: PROJECT  
 CITY OF LAS VEGAS

**LEGAL DESCRIPTION**  
 A PORTION OF THE EAST HALF (E 1/2) OF THE NORTHEAST QUARTER (NE 1/4) OF SECTION 25, AND THE WEST HALF (W 1/2) OF THE NORTHWEST QUARTER (NW 1/4) OF SECTION 30, TOWNSHIP 19 SOUTH, RANGE 60 EAST, M.D.M., CITY OF LAS VEGAS, CLARK COUNTY, NEVADA. BEING ALL OF PARCEL 3 ON FILE IN FILE 90 OF PARCEL MAPS, PAGE 69 IN THE OFFICE OF THE COUNTY RECORDER OF CLARK COUNTY, NEVADA.

**BASS OF BEARING**  
 NORTH 02°01'35" EAST BEING THE CENTERLINE OF DECATUR BLVD BETWEEN TROPICAL PARKWAY AND CENTENNIAL PARKWAY IN THE NORTHWEST QUARTER (NW 1/4) OF SECTION 30, TOWNSHIP 19 SOUTH, RANGE 61 EAST, M.D.M., CLARK COUNTY, NEVADA, AS SHOWN BY MAP IN THE OFFICE OF THE CLARK COUNTY, NEVADA RECORDER IN FILE 90 OF PARCEL MAPS PAGE 69.

**BENCHMARK**  
 CITY OF LAS VEGAS VERTICAL CONTROL RIVET AND PLATE IN TOP OF CURB NW CORNER OF TROPICAL PARKWAY & THOM BOULEVARD

STATION: BLV90  
 ELEVATION: 2568  
 ELEVATION= 697.5653 METERS (NAV88)  
 2288.60 FEET

|                |                 |
|----------------|-----------------|
| TITLE          | PROJECT         |
| WORK ORDER NO. | 070619          |
| DESIGN BY      | KDS             |
| DRAWN BY       | KDS/WK          |
| DATE           | Apr 15, 2008    |
| SCALE          | 1" = 40'        |
| SHEET          | 32 OF 45 SHEETS |
| CLY DWG NO.    | 10744968        |

**NOTICE TO CONTRACTOR !**

EXISTING UTILITY LOCATIONS SHOWN HEREON ARE APPROXIMATE ONLY. IT SHALL BE THE CONTRACTOR'S RESPONSIBILITY TO DETERMINE THE EXACT VERTICAL AND HORIZONTAL LOCATION OF ALL EXISTING UNDERGROUND UTILITIES PRIOR TO COMMENCING CONSTRUCTION. NO REPRESENTATION IS MADE THAT ALL EXISTING UTILITIES ARE SHOWN HEREON. THE ENGINEER ASSUMES NO RESPONSIBILITY FOR UTILITIES NOT SHOWN OR UTILITIES NOT SHOWN IN THEIR PROPER LOCATION.

AVOID CUTTING UNDERGROUND UTILITIES - IT'S COSTLY  
**CALL before you Dig**  
 1-800-227-2600  
 UNDERGROUND SERVICE (USA)

AVOID HITTING OVERHEAD POWER LINES - IT'S COSTLY  
**CALL BEFORE YOU DO OVERHEAD**  
 CALL 1-702-227-2929