




8" PUBLIC SEWER
STA. 14+42.75 TO STA. 15+83.22

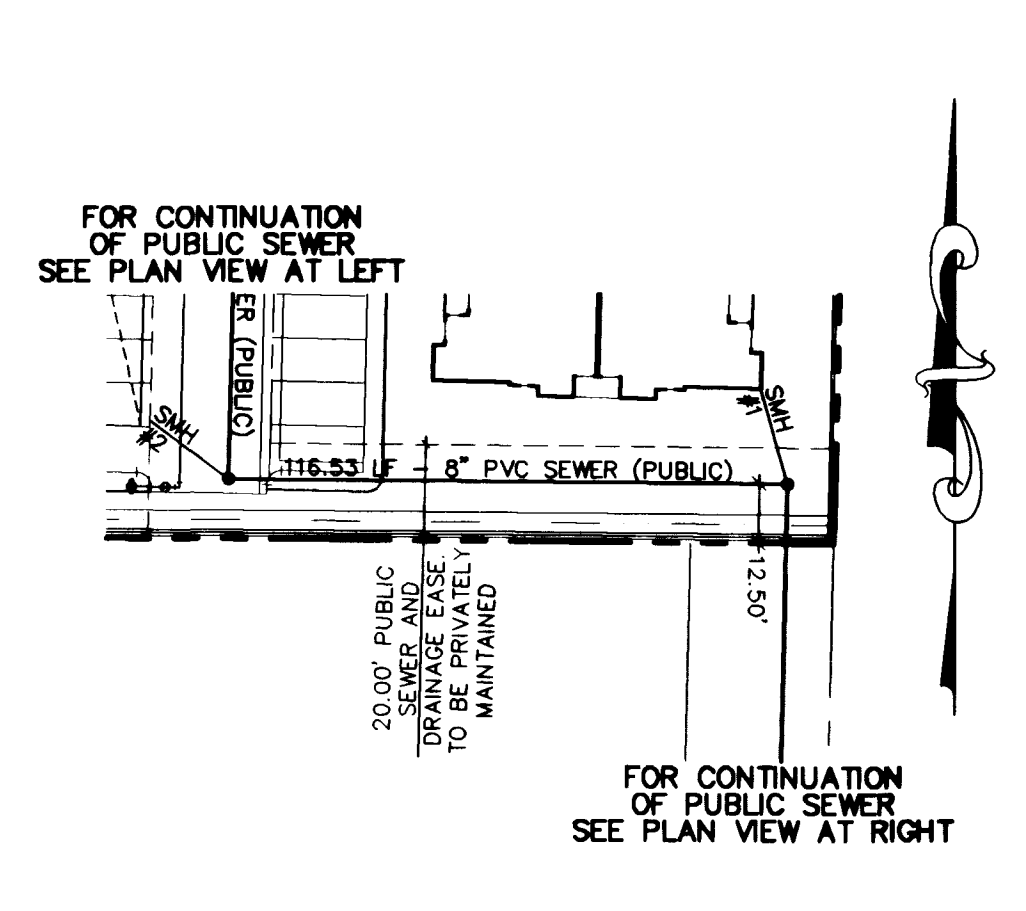

8" PUBLIC SEWER
STA. 13+26.22 TO STA. 14+42.75

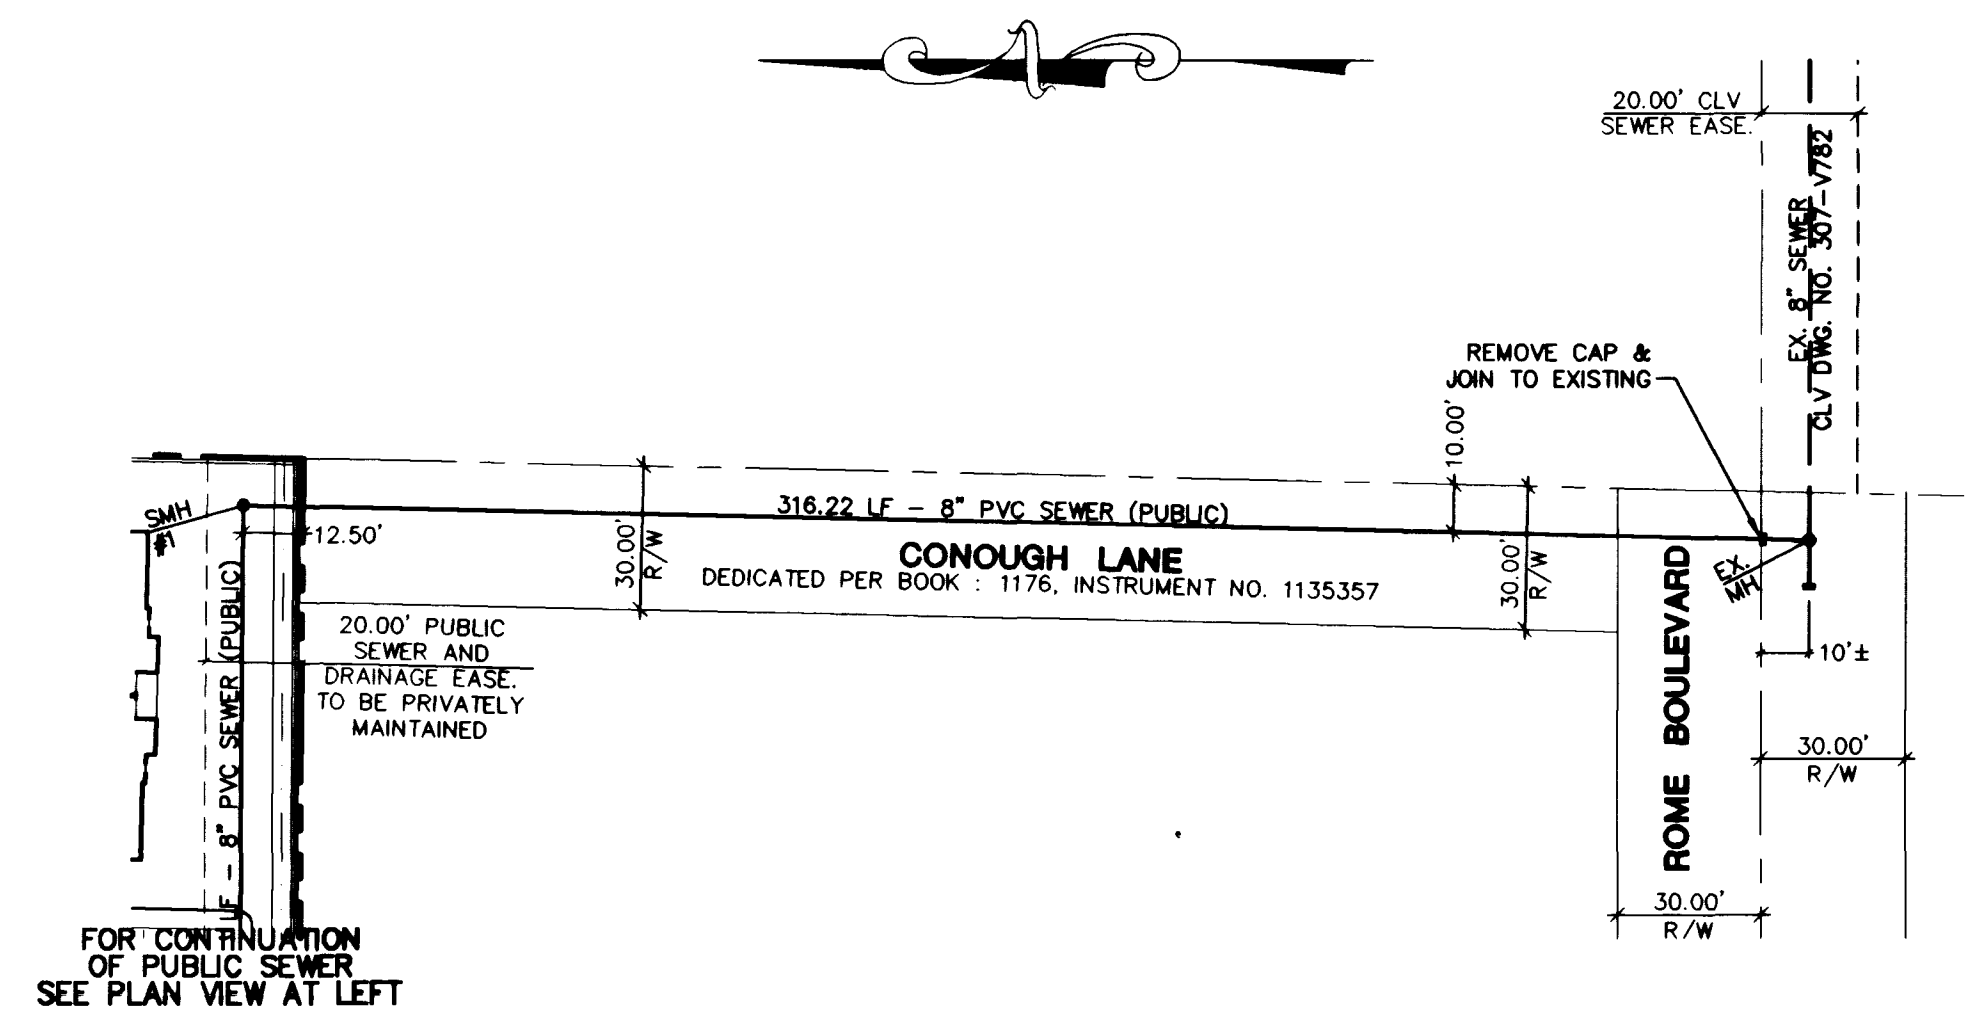

8" PUBLIC SEWER
STA. 10+00.00 TO STA. 13+26.22

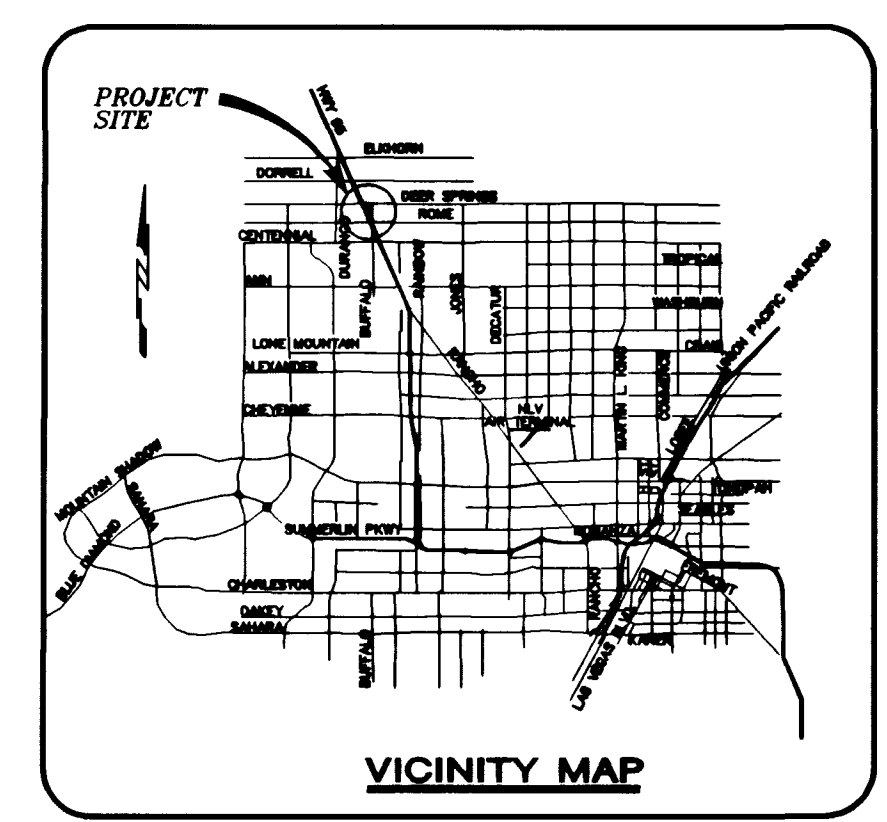

PROJECT BENCHMARK

TBM, T169 3" BRASS CAP USC & GS 50' EAST OF US 95 & 200' ± SOUTH OF CENTENNIAL ON 88 DATUM METER 734.5745=2410.02 FEET
TBM # 1LV9028NNE6

BASIS OF BEARINGS

THE BASIS OF BEARINGS FOR THIS PROJECT IS GRID NORTH, AS DEFINED BY THE NEVADA COORDINATE SYSTEM OF 1983 (NCS83), EAST ZONE, (2701), AS DETERMINED BY NORTH LAS VEGAS HARN CONTROL POINTS 700, 704, 714, AS SHOWN ON A RECORD OF SURVEY ON FILE IN THE CLARK COUNTY, NEVADA, RECORDER'S OFFICE IN FILE B2 OF SURVEYS, AT PAGE 52.

Avoid cutting underground utility lines. It's costly.





Avoid overhead power line contact

Call before you Dig
1-800-227-2600


Call before you OVERHEAD
1-702-593-6111

NOTE: CONTRACTOR SHALL VERIFY HORIZONTAL AND VERTICAL LOCATION OF EXISTING UTILITIES AND NOTIFY THE DESIGN ENGINEER IMMEDIATELY OF ANY DISCREPANCIES PRIOR TO CONSTRUCTION.

NOTE: ALL STATIONING IS BASED ON SEWER LENGTHS FROM MANHOLE TO MANHOLE.

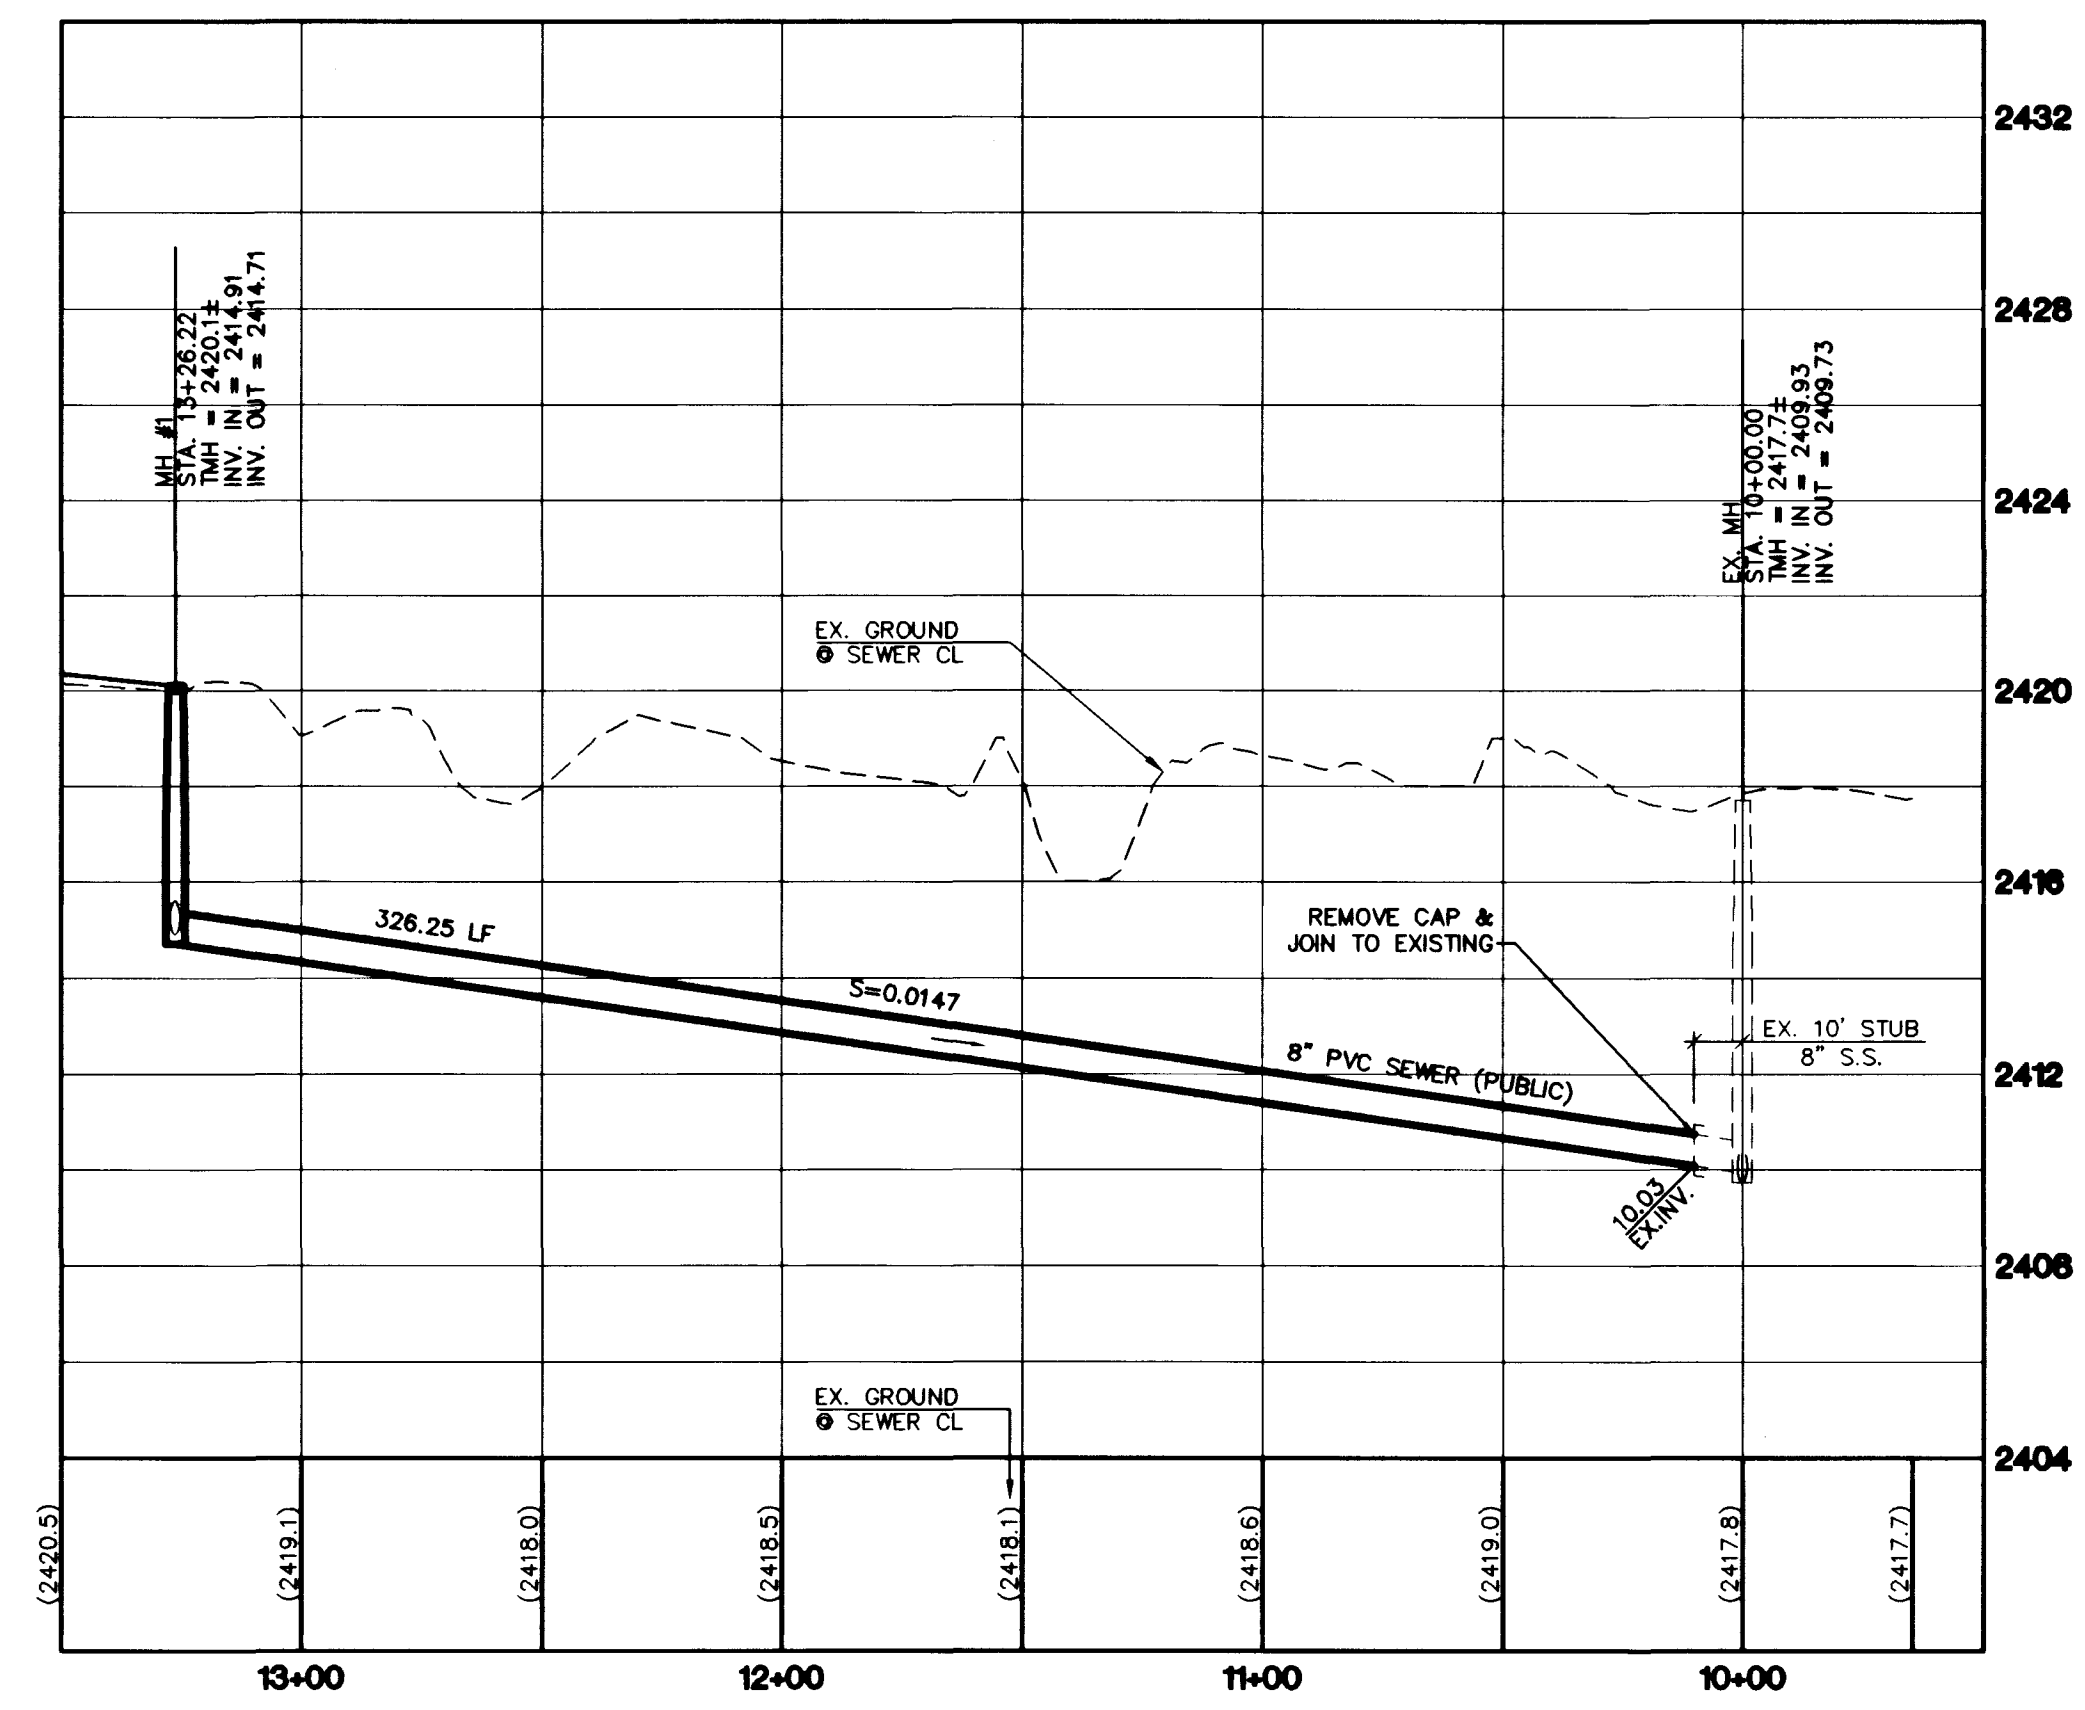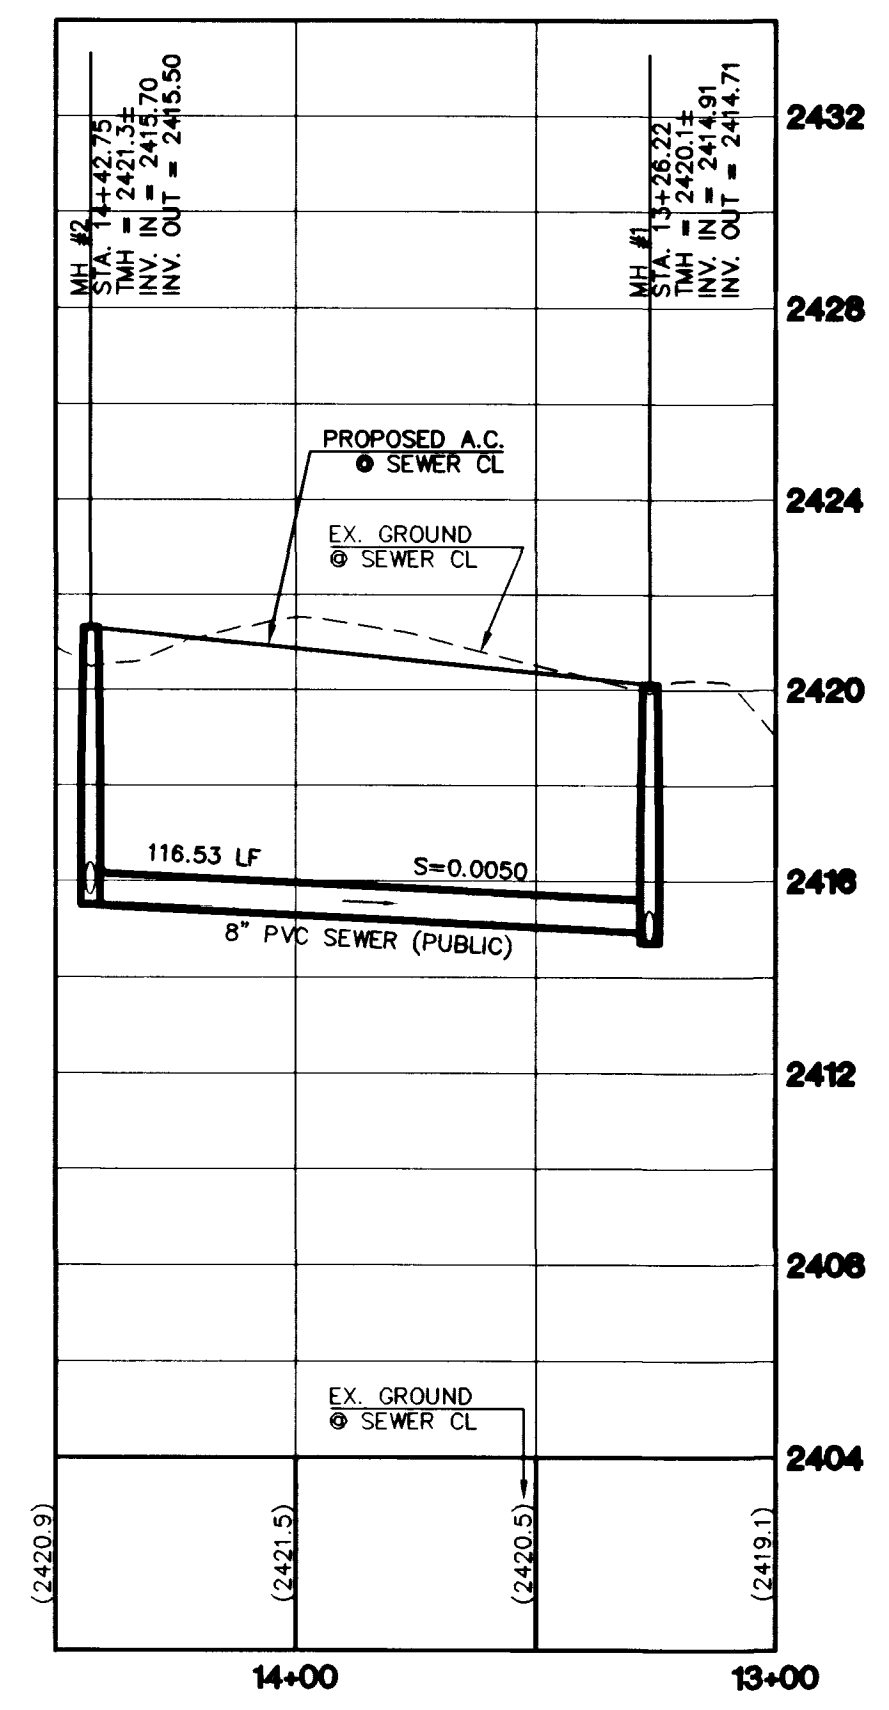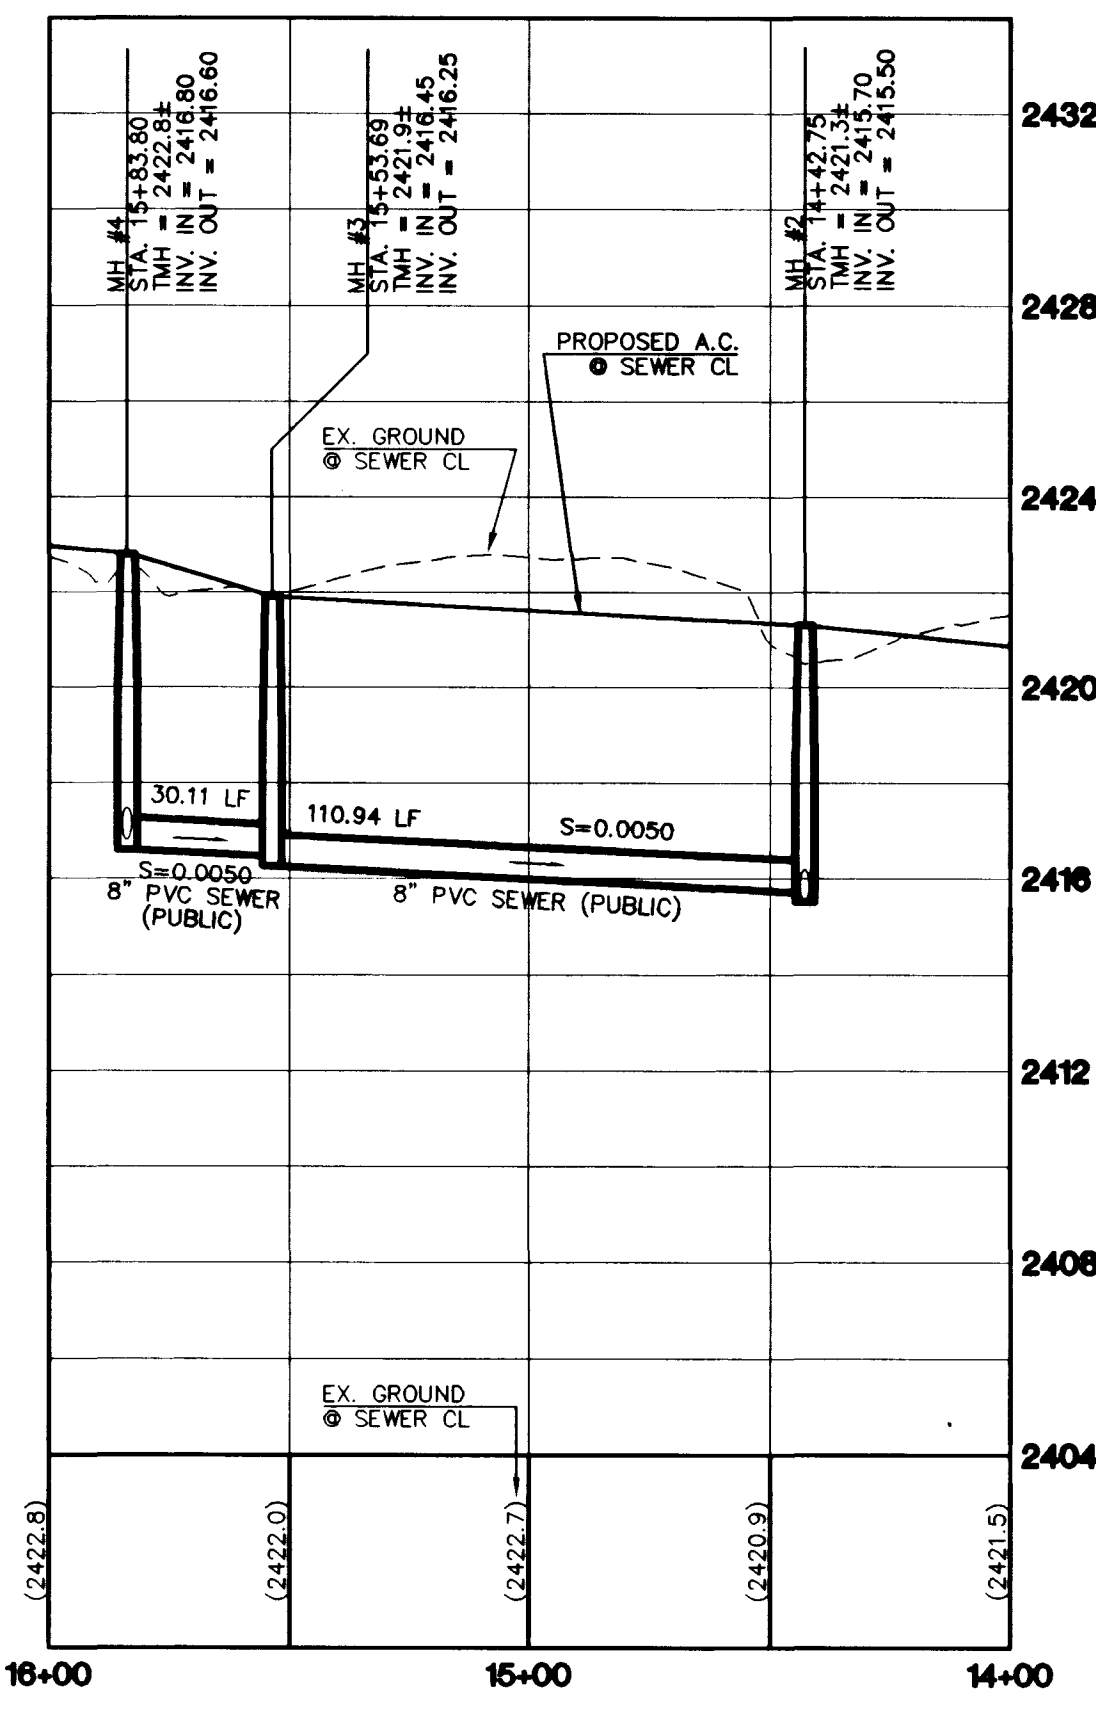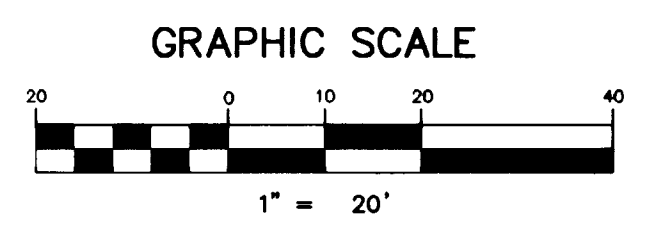

BIG SKY DEVELOPMENT 3838 BURNING TREE DRIVE LAS VEGAS, NEVADA 89129 (702) 395-2050		2727 SOUTH RAINBOW BOULEVARD LAS VEGAS, NEVADA 89102-5148 PH. (702) 873-7550 FAX (702) 382-2597 novada CONSULTING ENGINEERS & PLANNERS • LAND SURVEYORS	
DRAWN BY: MARCH 1999 dtb	DESIGNED BY: MARCH 1999 dtb	CHECKED BY: MARCH 1999 TEH	PROJECT NO: 5522 SCALE: 1"=40' HORIZ. N/A VERT.
PUBLIC 8" SEWER LINE PLAN AND PROFILE STA. 10+00.00 TO STA. 15+83.22		DEER SPRINGS APARTMENTS	
SHEET 991 15 OF 17 SHEETS		DRAWING NO. 107-V310B	

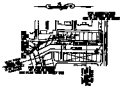

A. CABLE REEL



B. CABLE REEL



C. CABLE REEL




D. CABLE REEL



1:25
1:50
1:100

1:25
1:50
1:100

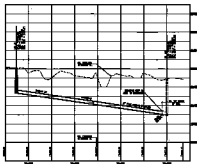

1:25
1:50
1:100

1:25
1:50
1:100

1:25
1:50
1:100

1:25
1:50
1:100

1:25
1:50
1:100

1:25
1:50
1:100



U.S. ARMY CORPS OF ENGINEERS